

MUP CORR-1 SN 10/2019

REGISTERED ARCHITECT

RODRIGO E. NOVION STATE OF WASHINGTON

NOVION GROUP INC.

8634B 3RD AVE NW
SEATTLE WASH 98117
PH(206)361.6133FAX361.6345
PROJECT ADDRESS

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OWNER/CLIENT

MRN HOMES LLC 1556 | 2TH AVE NE SEATTLE, MA 98||5 PH: 206-985-02|2


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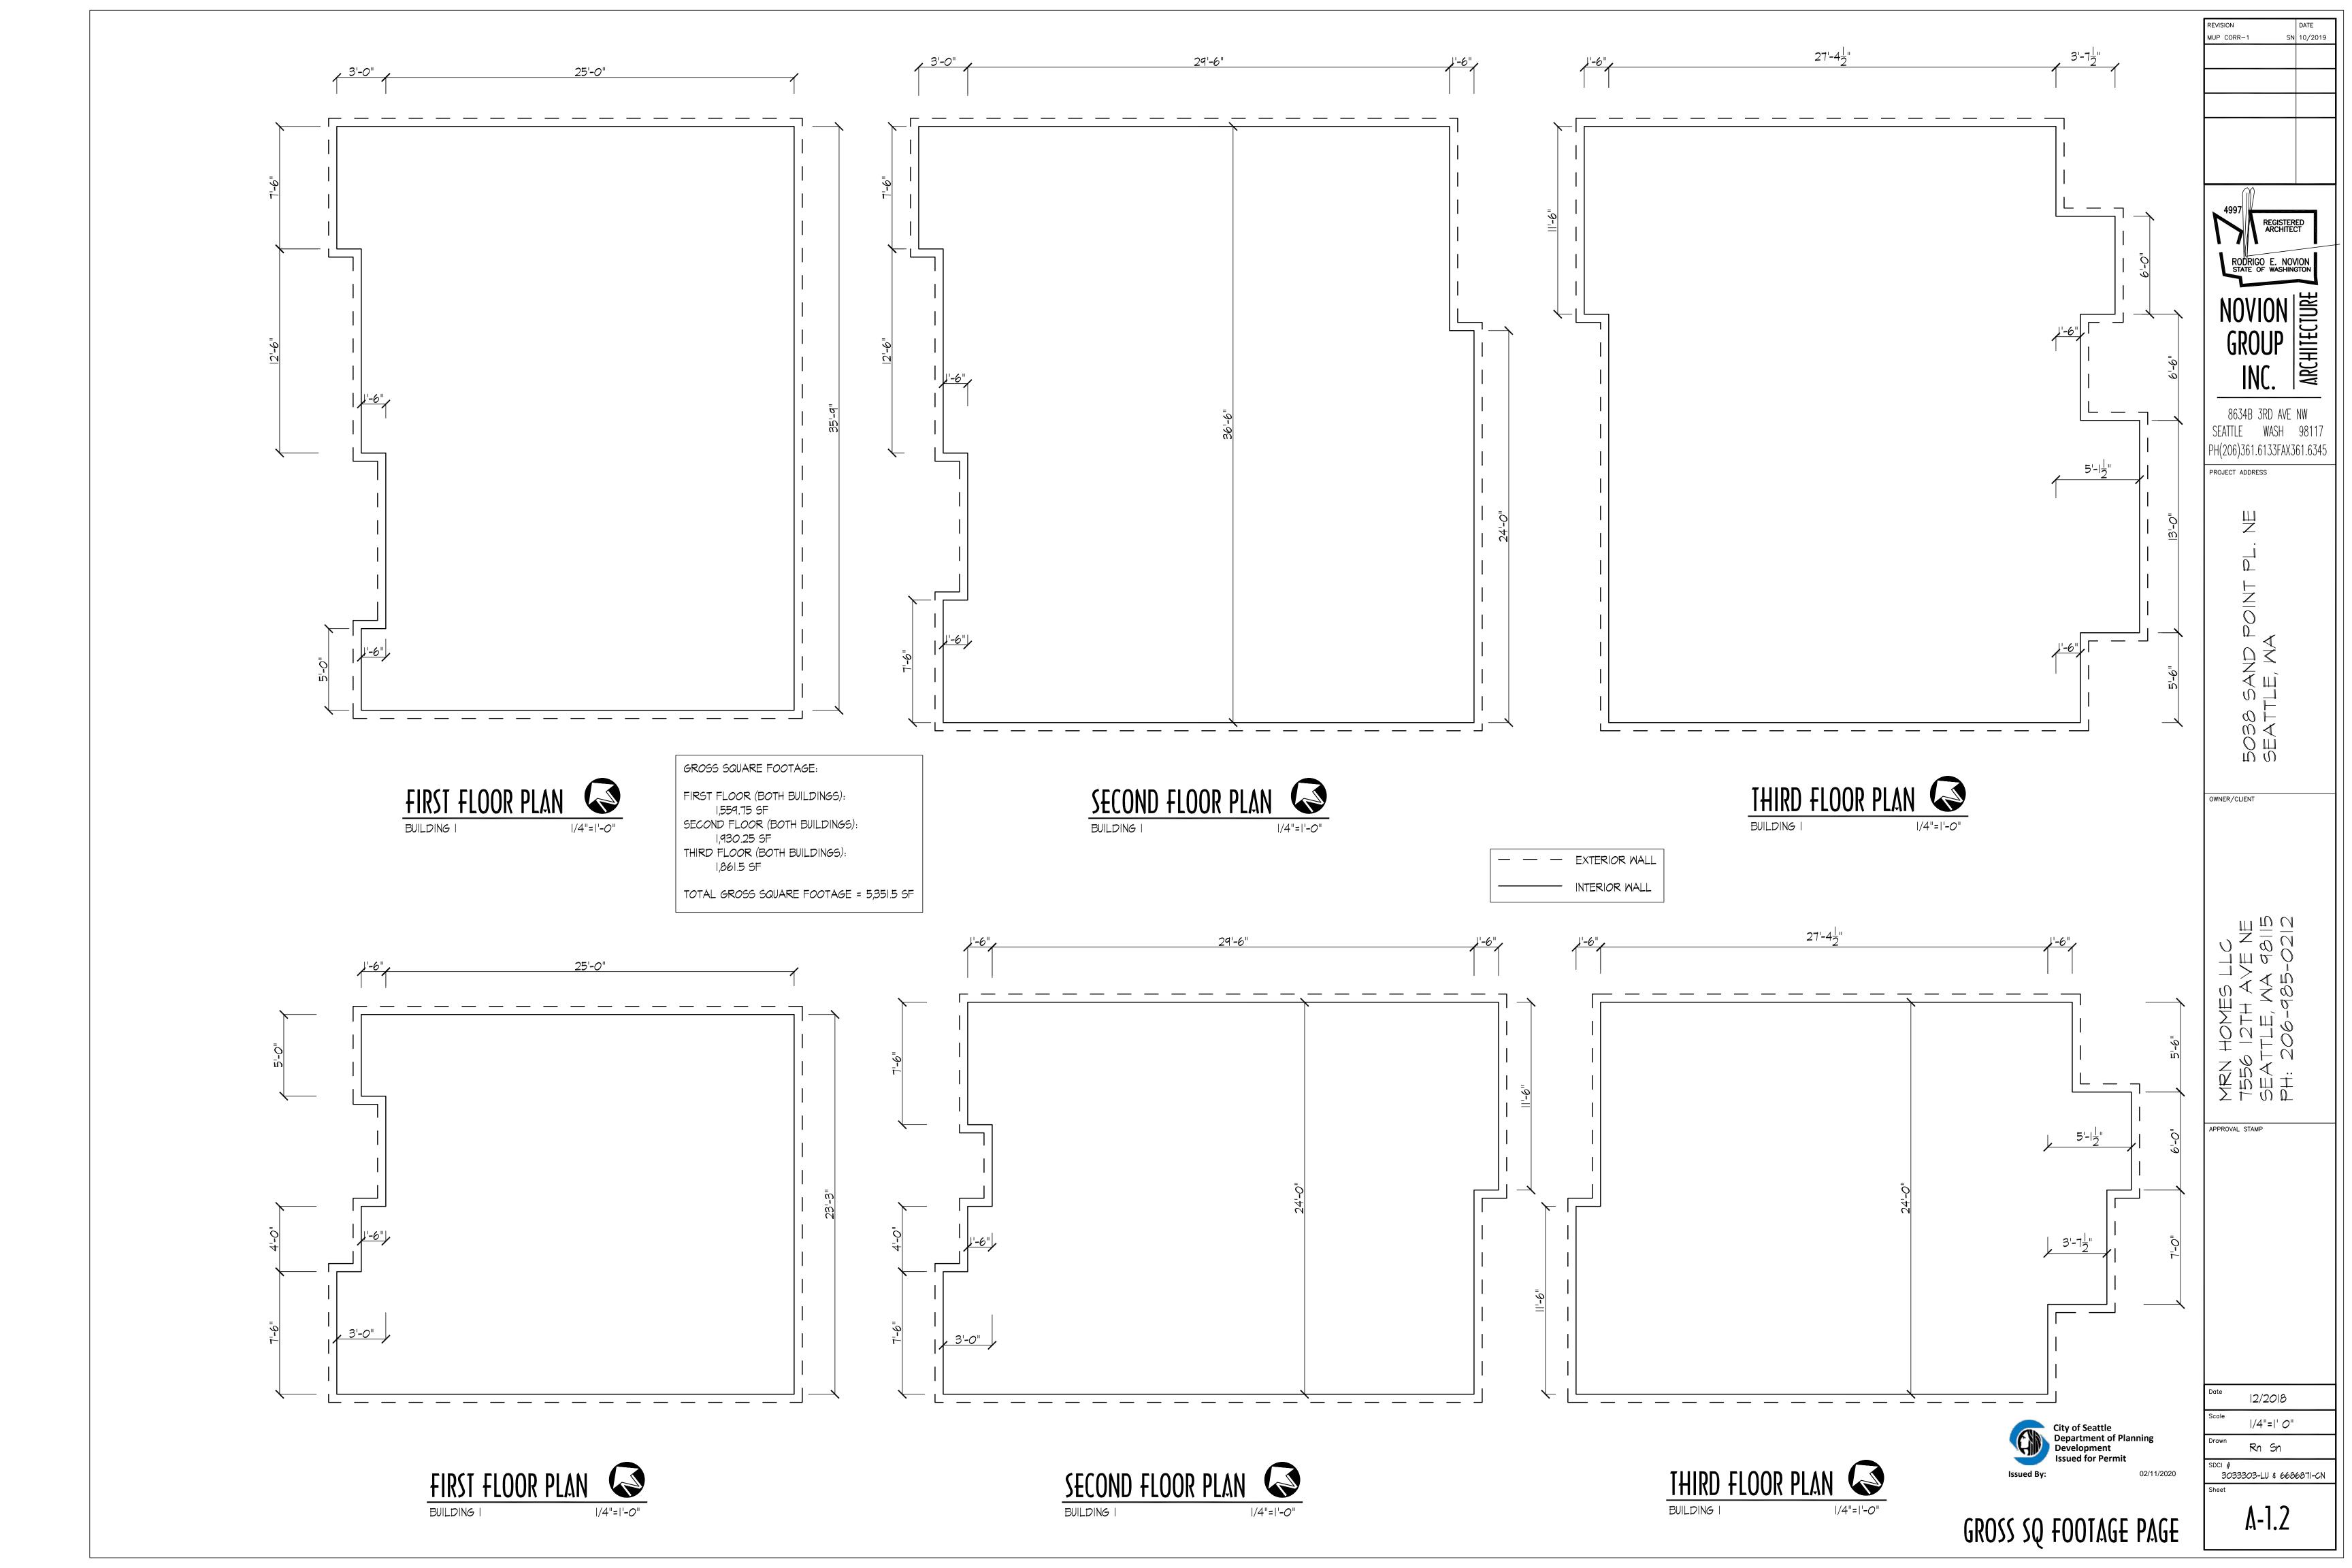
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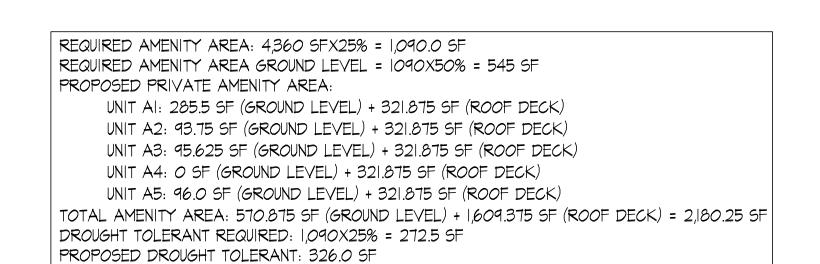
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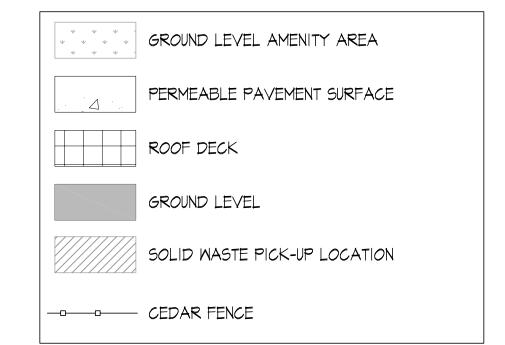




EXTERIOR LIGHTING TO BE SHIELDED AND DIRECTED AWAY FROM ADJACENT RESIDENTIAL USES PER SMC 23.45.534

PROVIDE 6' HIGH CEDAR FENCE TO PROTECT ADJACENT PROPERTIES FROM LIGHT AND GLARE.

FENCES ON TOP OF RETAINING WALLS ARE LIMITED TO 4' IN HEIGHT PER SMC 23.45.518.J.7.a

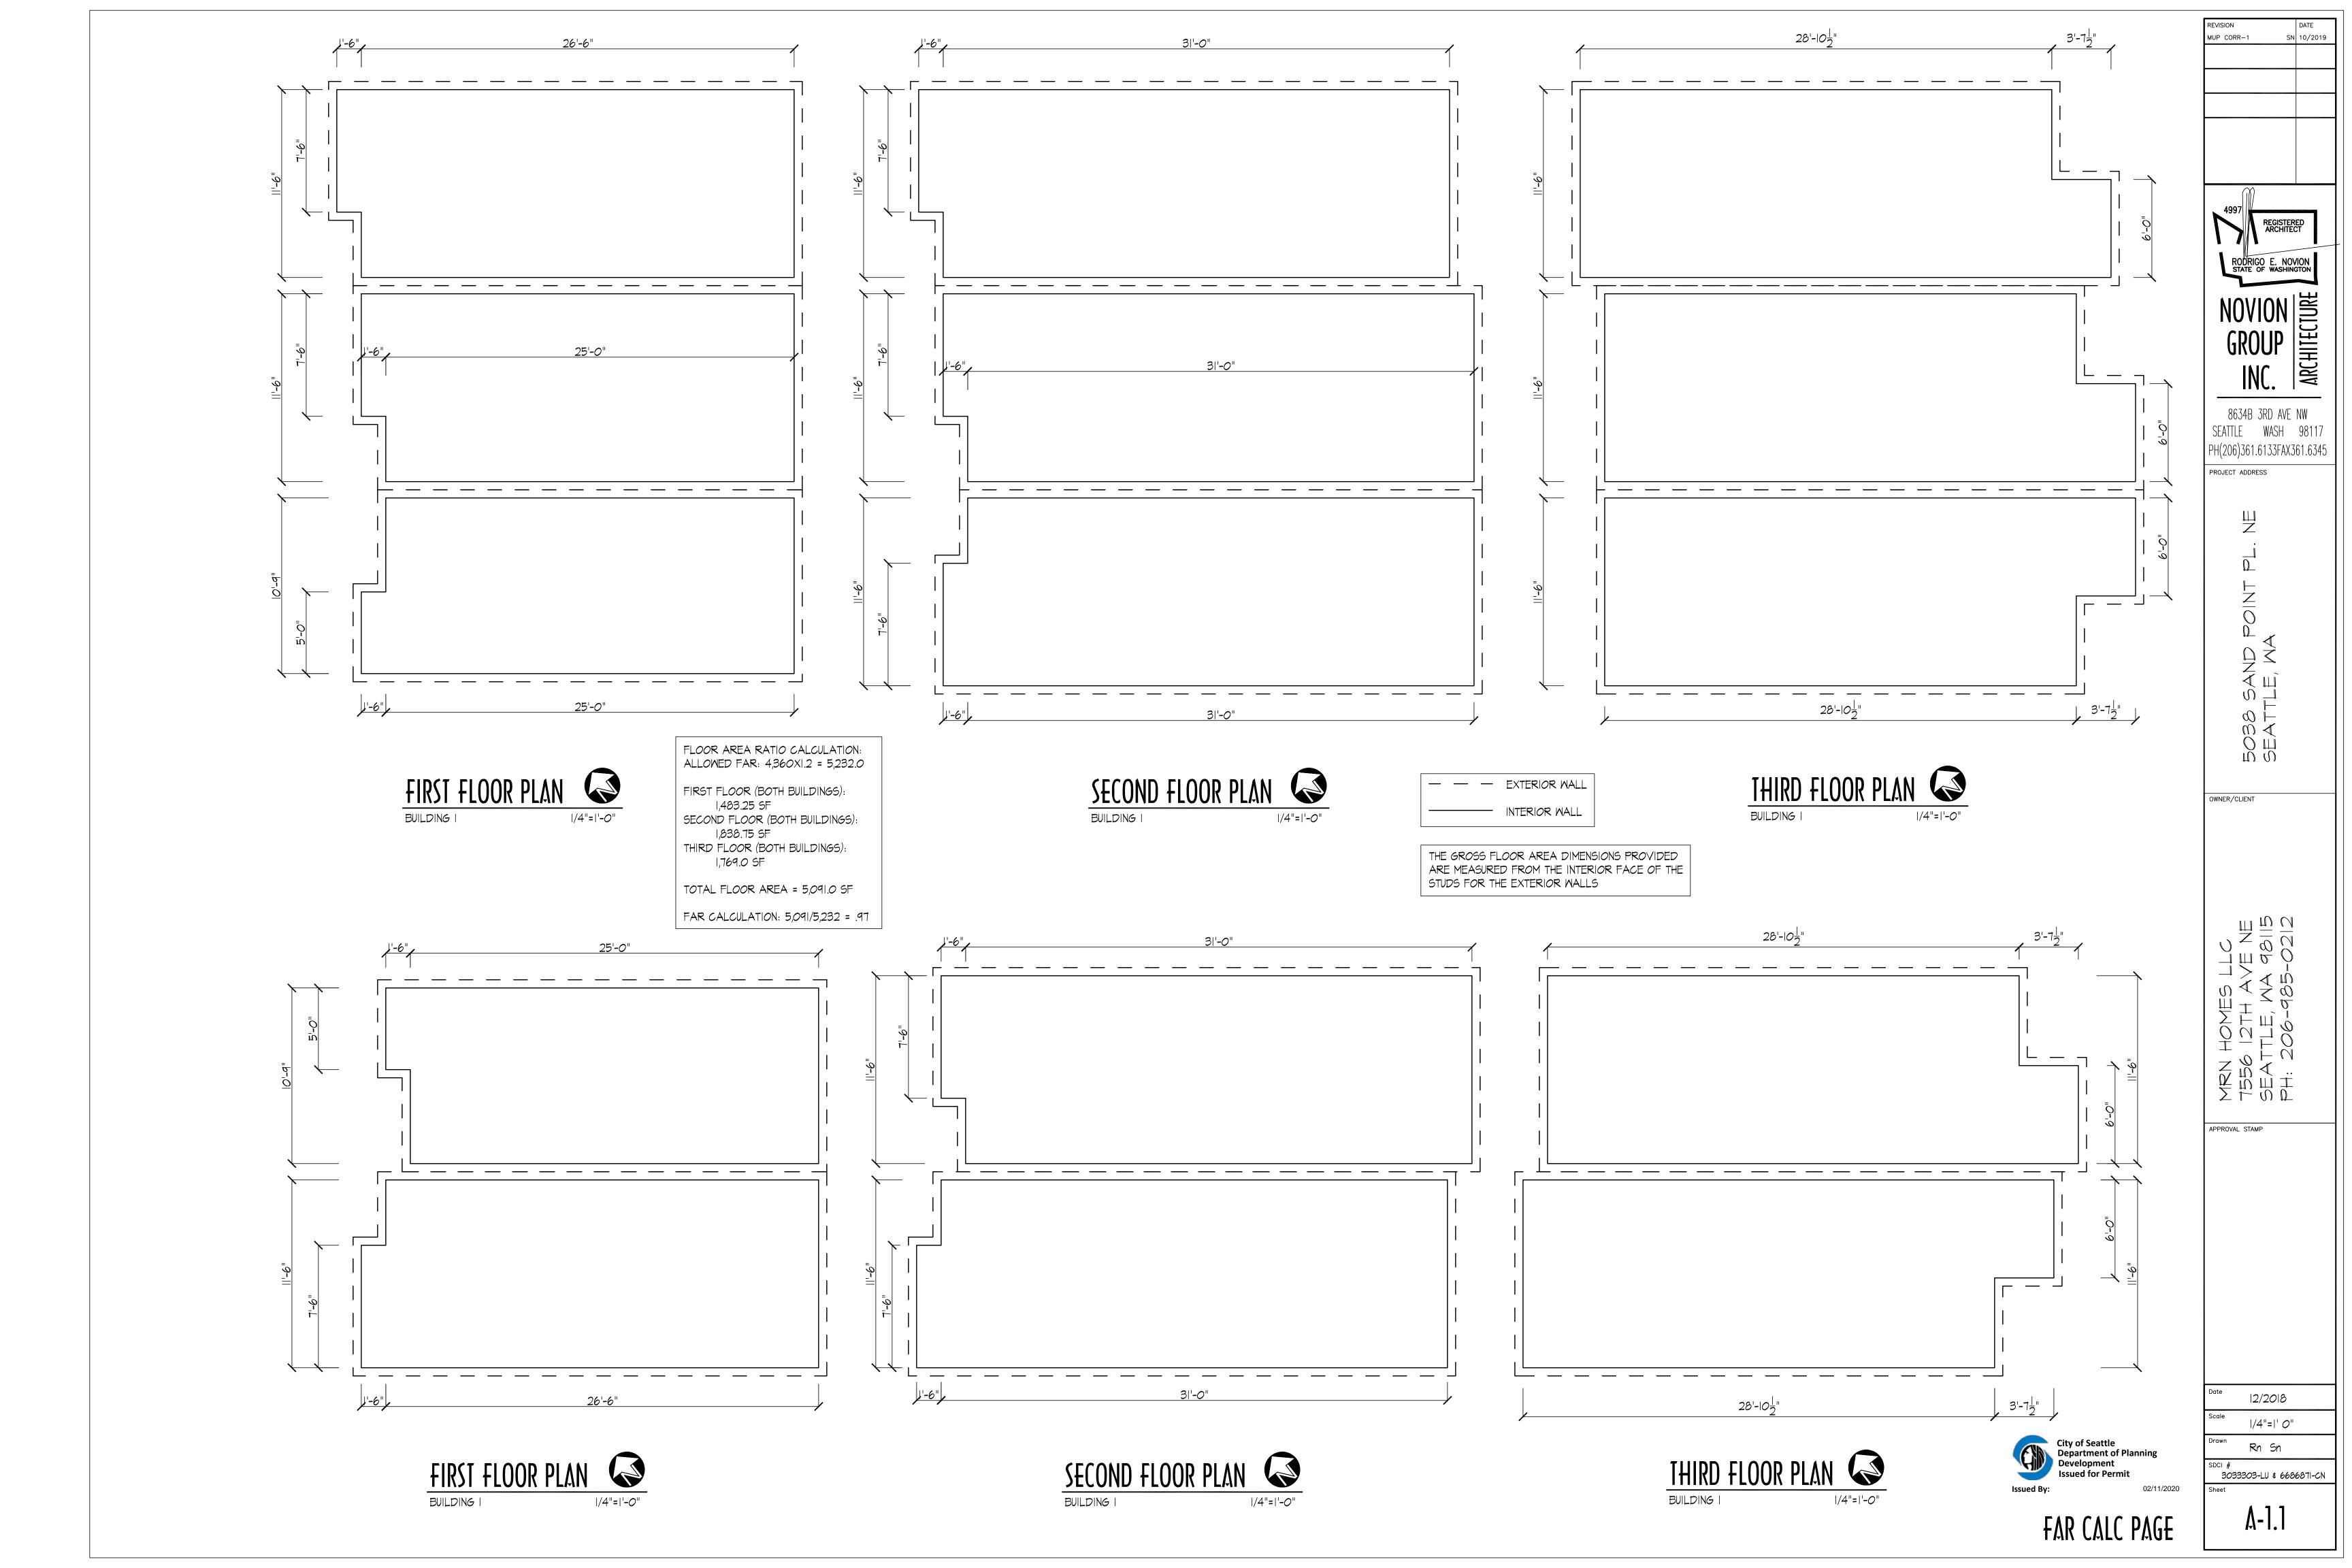



PRIVATE AMENITY AREA - UNIT A2:
GROUND LEVEL:
7.5'XI2.5' = 93.75 SF
ROOF DECK:
25.75'XI2.5' = 321.875 SF
TOTAL AMENITY AREA = 415.625 SF

PRIVATE AMENITY AREA - UNIT A3:
GROUND LEVEL:
7.5'X12.75' = 95.625 SF
ROOF DECK:
25.75'X12.5' = 321.875 SF
TOTAL AMENITY AREA = 417.5 SF

PRIVATE AMENITY AREA - UNIT A4: ROOF DECK: 25.75'XI2.5' = 32I.875 SF TOTAL AMENITY AREA = 32I.875 SF

PRIVATE AMENITY AREA - UNIT A5:
GROUND LEVEL:
6'X16' = 96.0 SF
ROOF DECK:
25.75'X12.5' = 321.875 SF
TOTAL AMENITY AREA = 417.875 SF

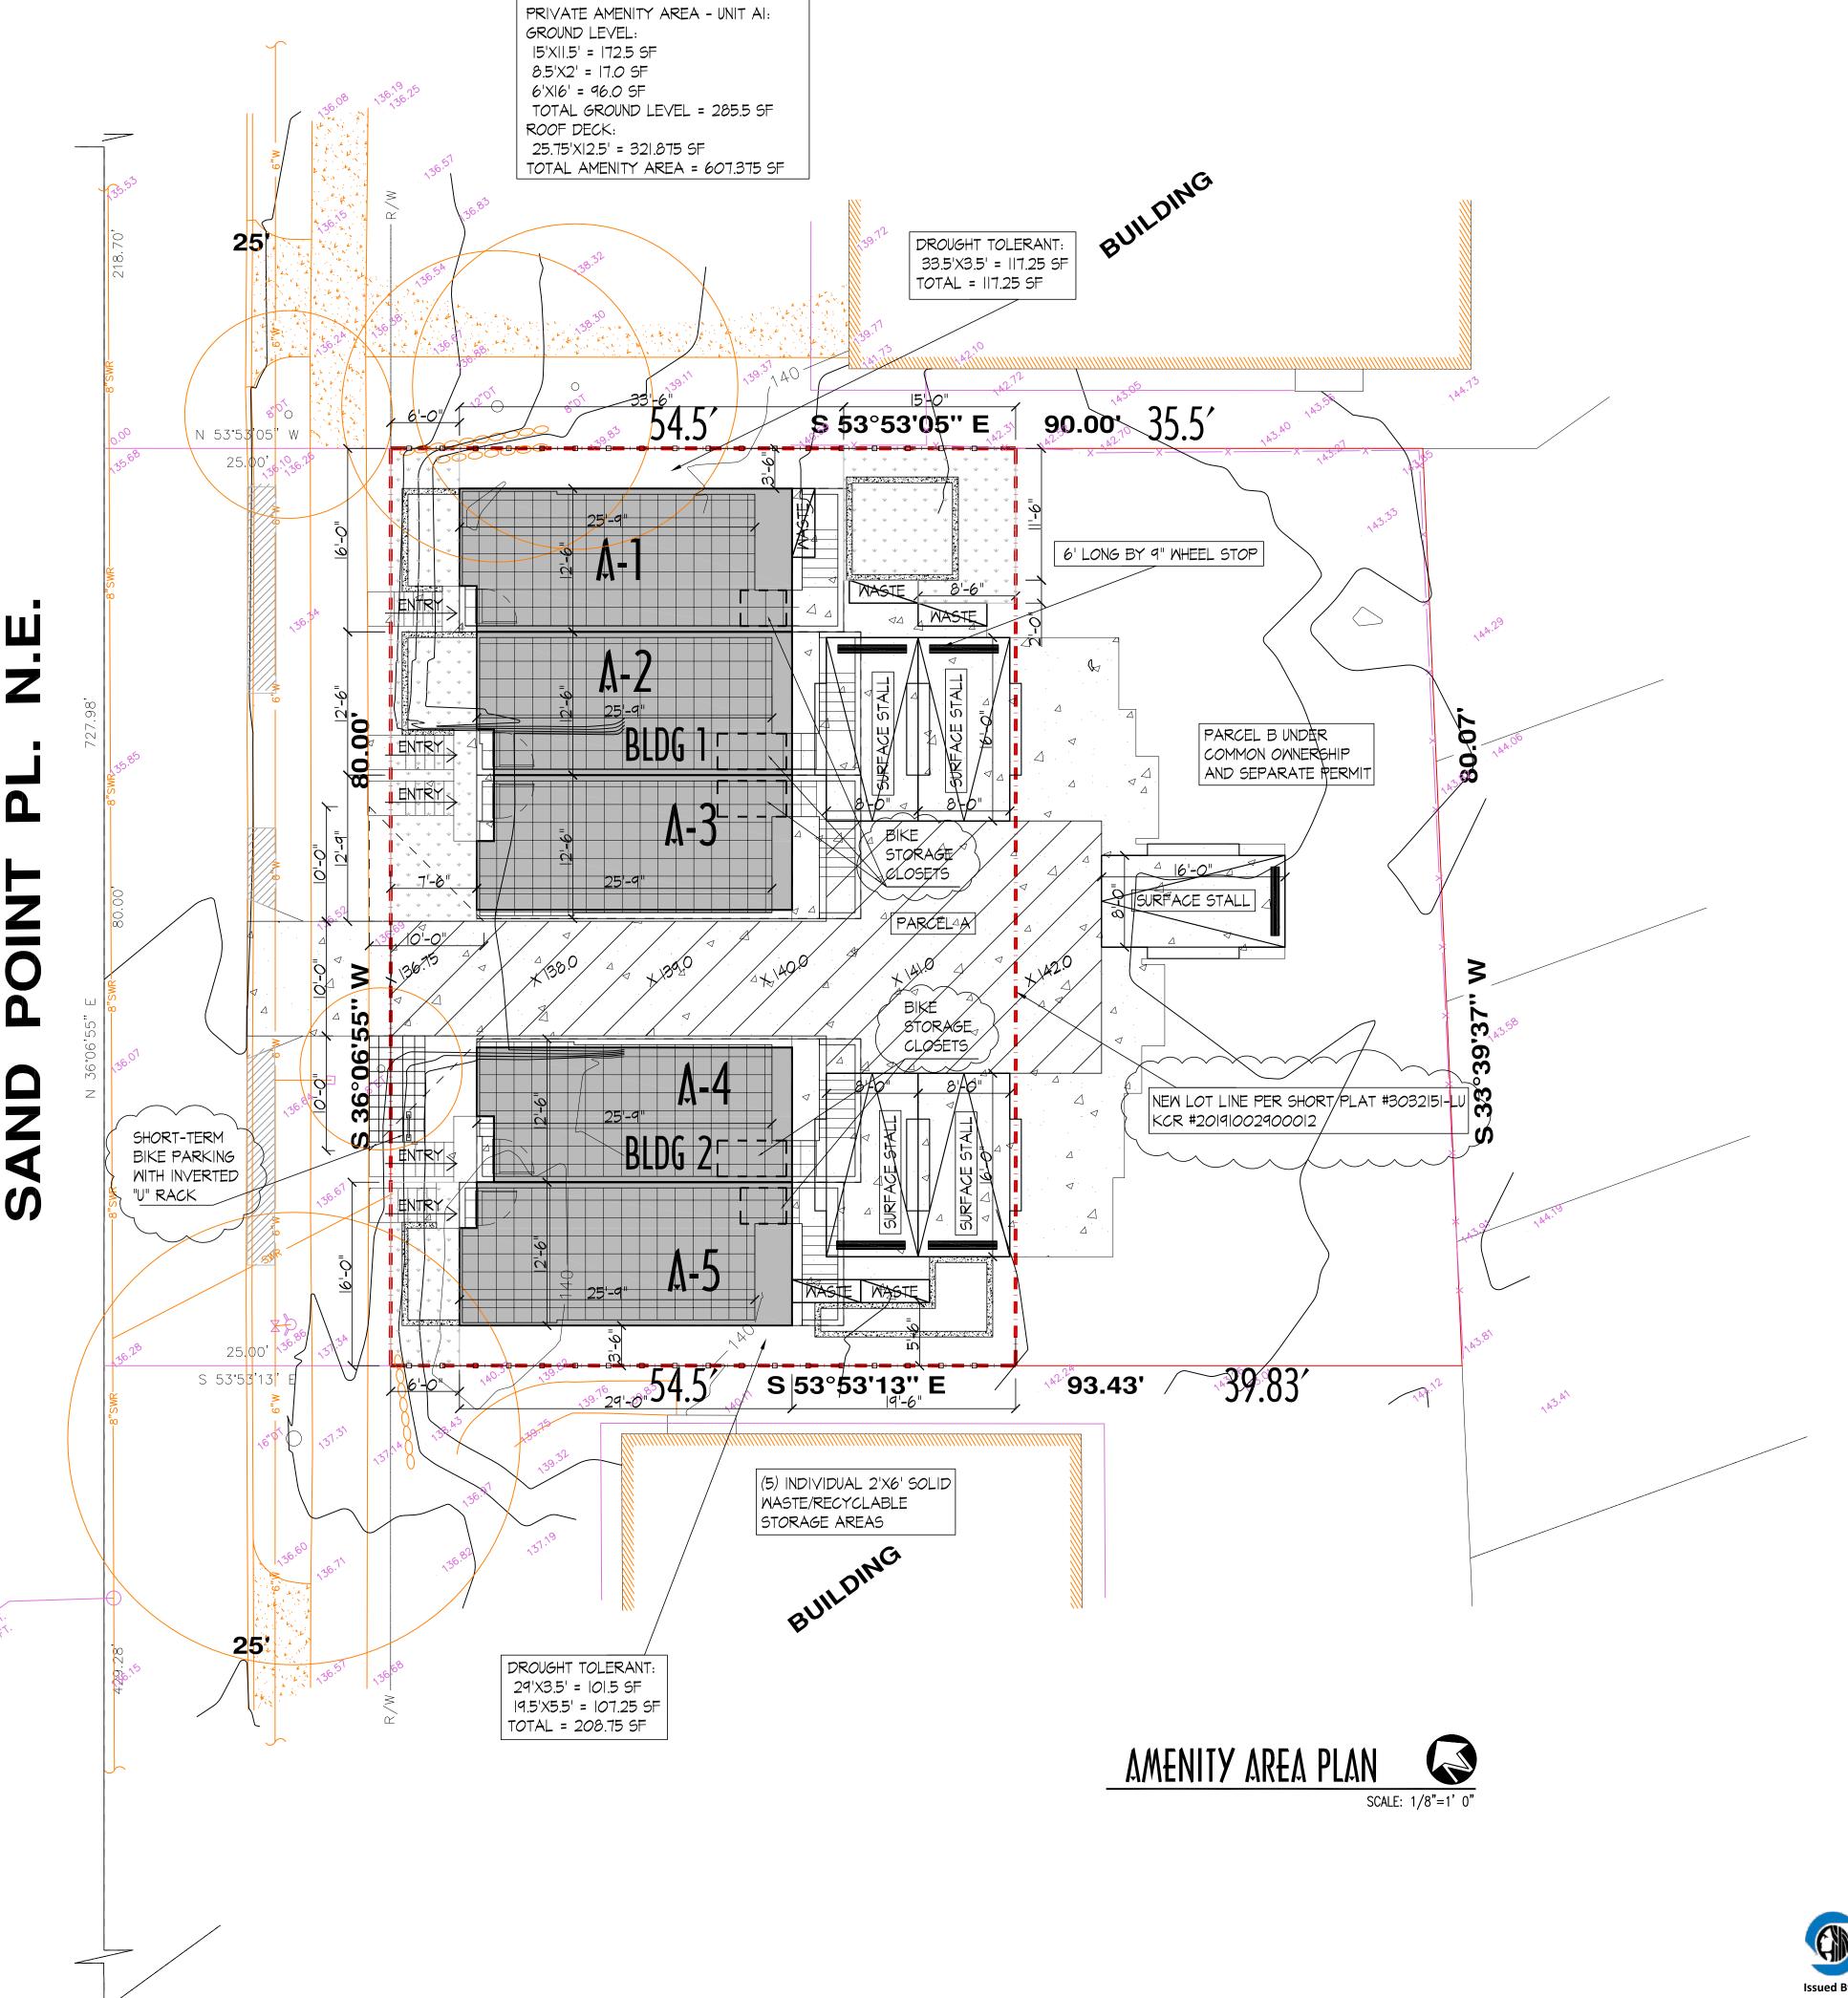

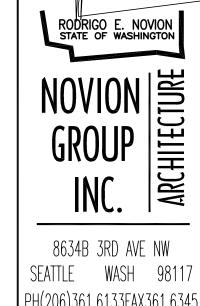

REGISTERED ARCHITECT

MUP CORR-1

SEATTLE WASH 98117 PH(206)361.6133FAX361.6345 PROJECT ADDRESS

> 5038 SAND POINT F SEATTLE, MA

OWNER/CLIENT

VRN HOMES LLO 1556 | 2TH AVE NE SEATTLE, MA 98||5 9H: 206-985-02|2

APPROVAL STAMP

City of Seattle
Department of Planning
Development
Issued for Permit

02/11/2020

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DETACHED ONE-FAMILY DWELLINGS AND DUPLEX .-

I. BUILDING ENTRANCE LOCKS. Building entrance doors, including garage doors, shall be capable of locking. They shall be equipped with a dead-locking latch bolt with at least a 1/2 - inch throw which penetrates the striker not less than 1/4 - inch. Building entrance doors shall be openable from the inside without use of a key or special knowledge or effort PER SRC R329.1.

EXCEPTION: Garage - to - exterior doors may be equipped with an electronically operated remote control device for opening and closing in lieu of a deadlocking latch bolt. When garage - to - exterior doors are equipped with remote control devices, garage - to - building doors need not be capable of locking.

2. OBSERVATION PORTS. Every building entrance door, other than garage doors, shall have a visitor observation port or glass side light. Observation ports shall be installed at a height of not less than 54 inches and not more than 66 inches from the floor PER SRC R329.2.

3. WINDOWS AND SLIDING DOORS. Dead bolts or other approved locking devices shall be provided on all sliding doors and openable windows. The lock shall be installed so that the mounting screws for the lock case are inaccessible from the outside PER SRC

EXCEPTION: Windows with sills located 10 feet or more above grade, or 10 feet or more above a deck, balcony or porch that is not readily accessible from grade except through a housing unit need not have operable inside latching devices

OWNER / CONTRACTOR NOTES

I. CONTRACTOR TO PHYSICALLY INSPECT SITE PRIOR TO COMMENCING ANY WORK, REPORT ANY DISCREPANCY TO ARCHITECT, CONTRACTOR TO REVIEW CONSTRUCTION DOCUMENTS PRIOR TO COMMENCING CONSTRUCTION. ANY QUESTIONS SHOULD BE DIRECTED TO OWNER AND/OR ARCHITECT CONTRACTOR TO CROSS-REFERENCE WITH CITY APPROVED PLANS FOR ANY CHANGES AND/OR

ADDITIONAL REQUIREMENTS BY CITY.

2. ALL INFORMATION CONTAINED IN THESE DOCUMENTS REPRESENTS A "BASIC LIMITED ARCHITECTURAL SERVICE" THAT REQUIRES THE CONTRACTOR TO BE KNOWLEDGEABLE AND EXPERIENCED WITH ALL ASPECTS OF CONSTRUCTION INCLUDING ALL BUILDING CODES AND REGULATIONS

IMPOSED BY THE CITY OR COUNTY AND ANY OTHER AGENCY HAVING JURISDICTION OVER THE PROJECT

3. ALL WORK SHALL COMPLY WITH THE STATE AND LOCAL ORDINANCES AND SHALL BE DONE TO THE HIGHEST STANDARDS OF CRAFTSMANSHIP BY JOURNEYMEN OF THE RESPECTIVE TRADES. 4. THE CONTRACTOR SHALL CARRY ALL INSURANCE REQUIRED BY LAW.

5. SAFETY, CARE OF ADJACENT PROPERTIES DURING CONSTRUCTION, COMPLIANCE WITH LOCAL, STATE, FEDERAL REGULATIONS REGARDING SAFETY ON SITE SHALL BE THE CONTRACTORS RESPONSIBILITY. 6. NO DEVIATIONS FROM THESE DOCUMENTS SHALL BE MADE WITHOUT WRITTEN APPROVAL FROM ARCHITECT. ANY CHANGES CAN AFFECT THE STRUCTURAL INTEGRITY AND CODE RELATED ISSUES OF THE STRUCTURE

7. ALL INFORMATION CONTAINED IN THESE DOCUMENTS IS FOR THE PURPOSE OF CONSTRUCTION PERMIT ACQUISITION AND CONSTRUCTION ONLY THE INFORMATION PROVIDED IS NOT INTENDED FOR ANY OTHER PURPOSE

AND NO OTHER USE IS INTENDED OR IMPLIED. e.g. PLAN INFORMATION IS NOT INTENDED TO BE USED AS A BASE FOR SALE OR TRANSFÉR OF REAL ESTATE 8. "BASIC LIMITED SERVICE" PROVIDES THE LOWEST LEVEL OF ARCHITECTURAL SERVICE WITH NO DRAWINGS AND SPECIFICATIONS PROVIDED OTHER THAN REQUIRED FOR PERMITS

9. UNLESS OTHERWISE SPECIFIED, ELECTRICAL, MECHANICAL, ETC. IS BIDDER DESIGNED, OWNER AND/OR AGENT (CONTRACTOR) IS RESPONSIBLE FOR

ALL WORK DONE ON SITE (FIELD) AS TO PROPER INSTALLATION, ETC IO. THE ARCHITECT MAY ASSIST IN COORDINATION WITH CONSULTANTS (SUCH AS SOILS, STRUCTURAL, CIVIL ENGINEERS, ETC.), BUT UNDER THE TERMS OF BASIC LIMITED SERVICE, RECEIVES NO COMPENSATION FOR AND ASSUMES NO RESPONSIBILITY OR LIABILITY FOR THE AREA OF THEIR (CONSULTANTS)

ACCEPTANCE OF THESE PLANS FOR CONSTRUCTION CONSTITUTES AN UNDERSTANDING OF ABOVE MENTIONED ITEMS AND BASIC LIMITED ARCHITECTURAL SERVICE AS DESCRIBED IN AGREEMENT BETWEEN OWNER/ARCHITECT

GENERAL NOTES

WORK AND EXPERTISE

ALL CONSTRUCTION TO COMPLY WITH THE 2015 SEATTLE RESIDENTIAL CODE, STATE ENERGY CODE, AND ALL OTHER APPLICABLE REGULATIONS AND AMENDMENTS. 2015 IRC WITH CITY OF SEATTLE AMENDMENTS

2. SECURE ALL REQUIRED PERMITS. CALL FOR ALL REQUIRED INSPECTIONS. 3. ALL FOOTINGS TO BEAR ON FIRM UNDISTURBED GROUND, MIN. 18 INCHES BELOW

FINISHED GRADE. REFER TO SOILS REPORT IF ONE IS AVAILABLE. 4. CONTRACTOR TO VERIFY EXISTING CONDITIONS, VERIFY DIMENSIONS, REPORT ANY DISCREPANCIES TO ARCHITECT. NO DEVIATIONS FROM PLANS SHOULD BE MADE WITHOUT ARCHITECTS WRITTEN APPROVAL.

5. PROVIDE SMOKE DETECTORS PER SRC R314 110 VOLTS, INTERCONNECT

6. ALL EXTERIOR DOORS TO COMPLY WITH SRC R329 MIN 1/2 INCH THROW ON DEAD BOLT OR DEAD LATCH FOR DOORS. VISITOR OBSERVATION PORT FOR EXTERIOR DOORS. WINDOWS WITHIN 10 FT. OF GRADE CAPABLE OF BEING LOCKED. ALL LOCKS MUST BE ABLE TO BE OPENED WITHOUT THE USE OF A KEY OR ANY SPECIAL KNOWLEDGE OR EFFORT FROM INSIDE.

7. SKYLIGHTS PER SRC R308.6

8. SAFETY GLAZING: PER SRC R308

GLAZING IN OR WITHIN 24 IN. FROM DOORS AND GLAZING WITHIN 18 IN. OF FLOOR OR WALKING SURFACE. ADDITIONAL HAZARDOUS LOCATIONS PER SRC R308.4 9. ALL WOOD IN CONTACT WITH CONCRT. TO BE PRESSURE TREATED PER SRC R317

10. ALL NAILING PER SRC TABLE R602.3, UNLESS OTHERWISE CALLED IN PLANS.

FIREBLOCKING, DRAFTSTOPS, AND FIRESTOPS PER SRC R302.11 & R302.12

12. LEDGER CONNECTIONS PER SRC R502.6.2

13. DOUBLE JOIST/BLOCK UNDER ALL BEARING PARTITIONS. SRC R502.4

14. INSTALL CROSS BRIDGING AT ALL JOIST SPANS EXCEEDING EIGHT FEET. R 502.7.1

PLAN NOTES:

2015 SEATTLE RESIDENTIAL CODE

I) STAIRS: COMPLY WITH SEC. R311.7 RISE AND RUN PER R311.7.5.1\$2

MAX RISE 73"-RISER HEIGHT DIFFERENCE WITHIN FLIGHT OF STARS SHALL NOT EXCEED 3" MIN RUN (TREAD DEPTH) SHALL BE 10"

HANDRAILS PER SRC R311.7.8, NOT LESS THAN 34" OR MORE THAN 38" ABOVE STAIR NOSING, ENDS SHALL BE RETURNED OR SHALL TERMINATE IN NEWEL POSTS OR SAFETY

HANDGRIP PER SRC R311.7.7.3: NOT LESS THAN 1 1/4" OR MORE THAN 2" DIA., PROJECT MIN. I I/2" FROM WALL. HEADROOM PER SRC R311.8.2 6'-8" MIN.

ENCLOSED USABLE SPACE UNDER STAIRS SHALL HAVE WALLS AND SOFFITS PROTECTED ON ENCLOSED SIDE PER I - HR. FIRE RESISTIVE CONSTRUCTION PER SRC 302.7 - FIRE BLOCK PER SRC R302.11, CONCEALED SPACES BETWEEN STAIR STRINGERS AT TOP AND BOTTOM OF RUN, BETWEEN STUDS AND ALONG LINE OF STAIRS AND SRC R302.11 FIRE BLOCK CONSTRUCTION

2) SRC R302.5.1 GARAGE OPENING PROTECTION: OPENINGS BETWEEN THE GARAGE AND RESIDENCE SHALL BE EQUIPPED WITH SOLID WOOD DOORS NOT LESS THAN 3/8 INCHES IN THICKNESS, SOLID OR HONEYCOMB CORE STEEL DOORS NOT LESS THAN 3/8 INCHES THICK, OR 20-MINUTE FIRE-RATED DOORS, EQUIPPED WITH A SELF CLOSING DEVICE. 3) TUB / SHOWER NOTES: COMPLY WITH SRC R307 NON ABSORBENT SURFACE. G.W.B., NO VAPOR BARRIER BEHIND WATER RESISTANT G.W.B. SPECIFIED AS BASE FOR TILE ON SHOWER ENCLOSURES, WATER RESISTANT G.W.B. NOT INSTALLED ON CEILING IF FRAMING EXCEEDS 12" OC. WALLS AND SHOWERS: WATERPROOF TO 72" ABOVE DRAIN INLET. SHOWER DOORS PER SRC R308 COMPLY WITH SAFETY GLAZING REQUIREMENTS. FIREBLOCK BETWEEN STUDS. SHOWER FLOW TO 2.5 G.P.M. MAX.

4) CRAWL SPACE ACCESS PER SRC R408.4, MIN. 18" X 24" UNOBSTRUCTED OPENING 5) ATTIC ACCESS PER SRC R807, 22" X 30" MIN. OPENING, 30" MIN. CLEAR

6) FACTORY-BUILT CHIMNEYS PER SRC RIOO5 AND FIREPLACES PER SRC RIOO4, TO BE U-L APPROVED LABELED AND INSTALLED PER MANUFACTURER SPECIFICATIONS AND U.M.C. 503. ANCHORED AT EACH FLOOR AND ROOF WITH 2 - 1 1/2" X 1/8" METAL STRAPS LOOPED AROUND OUTSIDE OF CHIMNEY INSTALLATION AND NAILED WITH NOT LESS THAN SIX(6) 8d NAILS PER STRAP EACH JOIST

FIRE BLOCK PER SRC R602.8, OPENING AT CHIMNEY, FIREPLACES AT CEILING AND FLOOR LEVELS, ATTIC SPACES AND CHIMNEY CHASES

7) GUARD RAILS PER SRC R312, MIN 36" HEIGHT PER SRC R312.1, 4" MAX. SPACE BETWEEN RAILS- SRC R312.3 TRIANGULAR OPENINGS AT RISER, TREAD, BOTTOM ELEMENT OF RAIL, 6" MAXIMUM, PER EXCEPTION

8) HOT WATER HEATER SHALL MEET NAECA 2004 REQUIREMENTS AND BE SO LABELED, ELECTRIC HOT WATER HEATER IN UNHEATED SPACES SHALL BE PLACED ON INCOMPRESSIBLE R-10 SURFACE

PROVIDE SEISMIC STRAPS TO STUDS

HEADROOM, ROOF VENTILATION PER SRC R806

9) EMERGENCY EGRESS PER SRC R310, MIN. NET CLEAR OPENABLE AREA OF 5.7 SQ. FT. NET CLEAR HEIGHT 24" MIN., MIN. NET CLEAR OPENABLE WIDTH 20", SILL HEIGHT NOT MORE THAN 44" ABOVE FLOOR.

10) SMOKE DETECTORS PER SRC R314, PROVIDE PERMANENT POWER SOURCE WITHOUT DISCONNECTING SWITCH WITH BATTERY BACKUP PER SRC R314.4, LOCATION PER SRC R314.3, EACH SLEEPING ROOM AND POINT CENTRALLY LOCATED IN CORRIDOR AND IN ACCORDANCE WITH APPROVED MANUF'R INSTRUCTIONS

II) INDIVIDUAL ROOM OUTSIDE AIR INLETS PER SRC MI508.4.5 - SHALL HAVE CONTROLLABLE AND SECURE OPENING NOT LESS THAN 4 SQ. INCHES. TESTED BY NAT RECOGNIZED STANDARD OR APPROVED AGENCY LOCATED SO AS NOT TO TAKE AIR FROM FOLLOWING:

CLOSER THAN 10' FROM APPLIANCE VENT OUTLET (UNLESS VENT IS 3'-O" ABOVE INLET) WHERE IT WOULD PICK UP OBJECTIONABLE ODORS, FUMES, OR FLAMMABLE VAPORS, HAZARDOUS OR UNSANITARY LOCATIONS.

SDCI Director's Rule 20-2017 Page 7 of 7

Green	Building	Standards	Commitment	Form	

1. If applying for a Master Use Permit, complete part A 2. If applying for a Building Permit, complete both parts A and B 3. Financially responsible party or owner shall sign and date 4. This Commitment shall be embedded on permit plan set SDCI Project Number 3033303-LU & 6686871-CN Project Address 5038 SAND POINT PL. NE Property Owner or Financially MICHAEL NELSON Responsible Party - Name MRN HOMES LLC Property Owner or Financially Responsible Party - Business Name Address 7556 12TH AVE NE City/State/Zip SEATTLE, WA 98115 MICHAEL@MRNHOMESLLC.COM

Part A - Prior to issuance of Master Use Permit or Building Permit

I agree to meet the green building standards pursuant to SMC 23.58D and Director's Rule 20-2017 by certifying the project under the selected building industry certification programs and building the proposed project to achieve an annual energy use of at least 15 percent lower than the standard reference design calculated in the 2015 Seattle Energy Code.

Select one building industry certification program:

o Leadership in Energy and Environmental Design (LEED) for Building Design and

Construction Gold, version 4

o LEED for Homes, Gold, version 4

Built Green 4 Star, single family new construction checklist WSEC 2015 (6/19/2017) Built Green 4 Star, multifamily new construction checklist 2017 Passive House Institute (PHI), Passive House Planning Package (PHPP) version 8.5 or 9

Passive House Institute US (PHIUS), version PHIUS + 2015
 Living Building Challenge (LBC) - Zero Energy Certification

o LBC Living Certification version 3.1 o Evergreen Sustainable Development Standard (ESDS), version 3.0

I acknowledge the compliance requirements in SMC 23.58D.004, and shall submit documentation from the selected certification program within 180 days from the issuance of the final certificate of occupancy (COO) or final inspection, if no COO is required. I acknowledge the requirements in SMC 23.58D.006, that failure to submit the certification report within 180 days, or by such later date as may be allowed by the director shall result in penalties of \$500 per day and up to a maximum penalty of 2 percent of construction value.

Part B - Prior to issuance of Building Permit

To ensure compliance with the selected building industry certification program, the referenced project has been registered or enrolled. The registration number or enrollment ID is 20198 F223

Property Owner or Financially Responsible Party Signature



WASHINGTON STATE ENERGY CODE NOTES- 2015:

R401.2 COMPLIANCE, PROJECTS SHALL COMPLY WITH SECTIONS IDENTIFIED AS "MANDATORY" AND WITH EITHER SECTIONS IDENTIFIED AS "PRESCRIPTIVE" OR THE PERFORMANCE APPROACH IN SECTION R405. IN ADDITION, ONE- AND TWO-FAMILY DWELLINGS AND TOWNHOUSES, AS DEFINED IN SECTION 101.2 OF THE INTERNATIONAL RESIDENTIAL CODE, SHALL COMPLY WITH SECTION R406.

R401.3 CERTIFICATE (MANDATORY). A PERMANENT CERTIFICATE SHALL BE COMPLETED AND POSTED ON OR WITHIN THREE FEET OF THE ELECTRICAL DISTRIBUTION PANEL BY THE BUILDER OR REGISTERED DESIGN PROFESSIONAL. THE CERTIFICATE SHALL BE COMPLETED BY THE BUILDER OR REGISTERED DESIGN PROFESSIONAL AND SHALL NOT COVER OR OBSTRUCT THE VISIBILITY OF THE CIRCUIT DIRECTORY LABEL SERVICE DISCONNECT LABEL OR OTHER REQUIRED LABELS. THE CERTIFICATE SHALL LIST THE PREDOMINANT R-VALUES OF INSULATION INSTALLED IN OR ON CEILING/ROOF, WALLS, FOUNDATION (SLAB, BELOW-GRADE WALL, AND/OR FLOOR) AND DUCTS OUTSIDE CONDITIONED SPACES; U-FACTORS FOR FENESTRATION AND THE SOLAR HEAT GAIN COEFFICIENT OF FENESTRATION, AND THE RESULTS FROM ANY REQUIRED DUCT SYSTEM AND BUILDING ENVELOPE AIR LEAKAGE TESTING DONE ON THE BUILDING. WHERE THERE IS MORE THAN ONE VALUE FOR EACH COMPONENT, THE CERTIFICATE SHALL LIST THE VALUE COVERING THE LARGEST AREA. THE CERTIFICATE SHALL LIST THE TYPES AND EFFICIENCIES OF HEATING, COOLING AND SERVICE WATER HEATING EQUIPMENT. WHERE A GAS-FIRED UNVENTED ROOM HEATER, ELECTRIC FURNACE, OR BASEBOARD ELECTRIC HEATER IS INSTALLED IN THE RESIDENCE, THE CERTIFICATE SHALL LIST "GAS-FIRED UNVENTED ROOM HEATER," "ELECTRIC FURNACE" OR "BASEBOARD ELECTRIC HEATER," AS APPROPRIATE. AN EFFICIENCY SHALL NOT BE LISTED FOR GAS-FIRED UNVENTED ROOM HEATERS, ELECTRIC FURNACES OR ELECTRIC BASEBOARD HEATERS.

R403. CONTROLS (MANDATORY). AT LEAST ONE THERMOSTAT SHALL BE PROVIDED FOR EACH SEPARATE HEATING AND COOLING SYSTEM

R403.I.I PROGRAMMABLE THERMOSTAT. WHERE THE PRIMARY HEATING SYSTEM IS A FORCED-AIR FURNACE. AT LEAST ONE THERMOSTAT PER DWELLING UNIT SHALL BE CAPABLE OF CONTROLLING THE HEATING AND COOLING SYSTEM ON A DAILY SCHEDULE TO MAINTAIN DIFFERENT TEMPERATURE SET POINTS AT DIFFERENT TIMES OF THE DAY. THE THERMOSTAT SHALL ALLOW FOR, AT A MINIMUM, A 5-2 PROGRAMMABLE SCHEDULE (WEEKDAYS/WEEKENDS) AND BE CAPABLE OF PROVIDING AT LEAST TWO PROGRAMMABLE SETBACK PERIODS PER DAY. THIS THERMOSTAT SHALL INCLUDE THE CAPABILITY TO SET BACK OR TEMPORARILY OPERATE THE SYSTEM TO MAINTAIN ZONE TEMPERATURES DOWN TO 55°F (13°C) OR UP TO 85°F (29°C). THE THERMOSTAT SHALL INITIALLY BE PROGRAMMED WITH A HEATING TEMPERATURE SET POINT NO HIGHER THAN 70°F (21°C) AND A COOLING TEMPERATURE SET POINT NO LOWER THAN 78°F (26°C). THE THERMOSTAT AND/OR CONTROL SYSTEM SHALL HAVE AN ADJUSTABLE DEADBAND OF NOT LESS THAN 10°F

SYSTEMS CONTROLLED BY AN OCCUPANT SENSOR THAT IS CAPABLE OF SHUTTING THE SYSTEM OFF WHEN NO OCCUPANT IS SENSED FOR A PERIOD OF UP TO 30 MINUTES 2. SYSTEMS CONTROLLED SOLELY BY A MANUALLY OPERATED TIMER CAPABLE OF OPERATING THE

SYSTEM FOR NO MORE THAN TWO HOURS.

R403.2.2 SEALING (MANDATORY). DUCTS, AIR HANDLERS, AND FILTER BOXES SHALL BE SEALED. JOINTS AND SEAMS SHALL COMPLY WITH EITHER THE INTERNATIONAL MECHANICAL CODE OR INTERNATIONAL RESIDENTIAL CODE, AS APPLICABLE. EXCEPTIONS:

AIR-IMPERMEABLE SPRAY FOAM PRODUCTS SHALL BE PERMITTED TO BE APPLIED WITHOUT ADDITIONAL JOINT SEALS

2. WHERE A DUCT CONNECTION IS MADE THAT IS PARTIALLY INACCESSIBLE, THREE SCREWS OR RIVETS SHALL BE EQUALLY SPACED ON THE EXPOSED PORTION OF THE JOINT SO AS TO PREVENT A HINGE

3. CONTINUOUSLY WELDED AND LOCKING-TYPE LONGITUDINAL JOINTS AND SEAMS IN DUCTS OPERATING AT STATIC PRESSURES LESS THAN 2 INCHES OF WATER COLUMN (500 PA) PRESSURE CLASSIFICATION SHALL NOT REQUIRE ADDITIONAL CLOSURE SYSTEMS. DUCTS SHALL BE LEAK TESTED IN ACCORDANCE WITH WSU RS-33, USING THE MAXIMUM DUCT LEAKAGE RATES SPECIFIED. DUCT TIGHTNESS SHALL BE VERIFIED BY EITHER OF THE FOLLOWING:

POSTCONSTRUCTION TEST: TOTAL LEAKAGE SHALL BE LESS THAN OR EQUAL TO 4 CFM (113.3 L/MIN) PER 100 SQUARE FEET (9.29 M2) OF CONDITIONED FLOOR AREA WHEN TESTED AT A PRESSURE DIFFERENTIAL OF O.I INCHES W.G. (25 PA) ACROSS THE ENTIRE SYSTEM. INCLUDING THE MANUFACTURER'S AIR HANDLER ENCLOSURE. ALL REGISTER BOOTS SHALL BE TAPED OR OTHERWISE SEALED DURING THE TEST. LEAKAGE TO OUTDOORS SHALL BE LESS THAN OR EQUAL TO 4 CFM (133.3L/MIN) PER 100 SQUARE FEET OF CONDITIONED FLOOR AREA.

2. ROUGH-IN TEST: TOTAL LEAKAGE SHALL BE LESS THAN OR EQUAL TO 4 CFM (113.3 L/MIN) PER 100 SQUARE FEET (9.29 M2) OF CONDITIONED FLOOR AREA WHEN TESTED AT A PRESSURE DIFFERENTIAL OF O.I INCHES W.G. (25 PA) ACROSS THE SYSTEM, INCLUDING THE MANUFACTURER'S AIR HANDLER ENCLOSURE. ALL REGISTERS SHALL BE TAPED OR OTHERWISE SEALED DURING THE TEST. IF THE AIR HANDLER IS NOT INSTALLED AT THE TIME OF THE TEST, TOTAL LEAKAGE SHALL BE LESS THAN OR EQUAL TO 3 CFM (85 L/MIN) PER 100 SQUARE FEET (9.29 M2) OF CONDITIONED FLOOR AREA. EXCEPTION: THE TOTAL LEAKAGE TEST IS NOT REQUIRED FOR DUCTS AND AIR HANDLERS LOCATED ENTIRELY WITHIN THE BUILDING THERMAL ENVELOPE. DUCTS LOCATED IN CRAWL SPACES DO NOT QUALIFY FOR THIS EXCEPTION.

R403.2.3 BUILDING CAVITIES (MANDATORY). BUILDING FRAMING CAVITIES SHALL NOT BE USED AS DUCTS OR PLENUMS. INSTALLATION OF DUCTS IN EXTERIOR WALLS, FLOORS OR CEILINGS SHALL NOT DISPLACE REQUIRED ENVELOPE INSULATION.

R403.3 MECHANICAL SYSTEM PIPING INSULATION (MANDATORY). MECHANICAL SYSTEM PIPING CAPABLE OF CARRYING FLUIDS ABOVE 105°F (41°C) OR BELOW 55°F (13°C) SHALL BE INSULATED TO A MINIMUM OF R-6.

R403.3.I PROTECTION OF PIPING INSULATION. PIPING INSULATION EXPOSED TO WEATHER SHALL BE PROTECTED FROM DAMAGE, INCLUDING THAT CAUSED BY SUNLIGHT, MOISTURE, EQUIPMENT MAINTENANCE AND WIND, AND SHALL PROVIDE SHIELDING FROM SOLAR RADIATION THAT CAN CAUSE DEGRADATION OF THE MATERIAL. ADHESIVE TAPE SHALL NOT BE PERMITTED

R403.4.1 CIRCULATING HOT WATER SYSTEMS (MANDATORY). CIRCULATING HOT WATER SYSTEMS SHALL BE PROVIDED WITH AN AUTOMATIC OR READILY ACCESSIBLE MANUAL SWITCH THAT CAN TURN OFF THE HOT WATER CIRCULATING PUMP WHEN THE SYSTEM IS NOT IN USE

R403.5 MECHANICAL VENTILATION (MANDATORY). THE BUILDING SHALL BE PROVIDED WITH VENTILATION THAT MEETS THE REQUIREMENTS OF THE INTERNATIONAL RESIDENTIAL CODE OR INTERNATIONAL MECHANICAL CODE, AS APPLICABLE, OR WITH OTHER APPROVED MEANS OF VENTILATION, OUTDOOR AIR INTAKES AND EXHAUSTS SHALL HAVE AUTOMATIC OR GRAVITY DAMPERS THAT CLOSE WHEN THE VENTILATION SYSTEM IS NOT OPERATING.

R403.5.1 WHOLE-HOUSE MECHANICAL VENTILATION SYSTEM FAN EFFICACY. MECHANICAL VENTILATION Issued Bv: SYSTEM FANS SHALL MEET THE EFFICACY REQUIREMENTS OF TABLE R403.5.1. EXCEPTION: WHERE MECHANICAL VENTILATION FANS ARE INTEGRAL TO TESTED AND LISTED HVAC EQUIPMENT, THEY SHALL BE POWERED BY AN ELECTRONICALLY COMMUTATED MOTOR.

R403.6 EQUIPMENT SIZING (MANDATORY). HEATING AND COOLING EQUIPMENT SHALL BE SIZED IN ACCORDANCE WITH ACCA MANUAL S BASED ON BUILDING LOADS CALCULATED IN ACCORDANCE WITH ACCA MANUAL J OR OTHER APPROVED HEATING AND COOLING CALCULATION METHODOLOGIES.

R404. LIGHTING EQUIPMENT (MANDATORY). A MINIMUM OF 75 PERCENT OF PERMANENTLY INSTALLED LAMPS IN LIGHTING FIXTURES SHALL BE HIGH-EFFICACY LAMPS.

R404.I.I LIGHTING EQUIPMENT (MANDATORY). FUEL GAS LIGHTING SYSTEMS SHALL NOT HAVE CONTINUOUSLY BURNING PILOT LIGHTS.

REGISTERED ARCHITECT RODRIGO E. NOVION STATE OF WASHINGTON

MUP CORR-1

8634B 3RD AVE NW SEATTLE WASH 98117 PH(206)361.6133FAX361.6345

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Department of Planning

Issued for Permit 02/11/2020

12/2018

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FIRE DEPARTMENT NOTES:

I. MULTIPLE STATION SMOKE ALARMS SHALL BE PROVIDED IN THE FOLLOWING LOCATIONS PER 2012 SRC R314:

a. IN EACH ROOM USED FOR SLEEPING PURPOSES.

b. ON THE CEILING OR WALL OUTSIDE OF EACH SEPARATE SLEEPING AREA IN THE IMMEDIATE VICINITY OF BEDROOMS.

C. IN EACH LEVEL WITHIN A DWELLING UNIT, INCLUDING BASEMENTS AND EXCLUDING CRAWL SPACES AND UNINHABITABLE ATTICS.

2. NO STORAGE OR USE OF FLAMMABLE OR COMBUSTIBLE LIQUIDS, CUTTING OR WELDING OPERATIONS, ROOFING OPERATIONS OR USE OF FLAMMABLE GAS FOR TEMPORARY HEATING OR DRYING SHALL BE CONDUCTED ON ANY CONSTRUCTION SITE WITHOUT FIRST HAVING OBTAINED A SPECIFIC PERMIT FROM THE SEATTLE FIRE DEPARTMENT FOR THESE HAZARDOUS ACTIVITIES. PLEASE CALL 206-386-1025 FOR PERMIT INFORMATION.

3. IF THERE IS AN EXISTING UNDERGROUND HEATING OIL TANK AT THE SITE, IT SHALL BE DECOMMISSIONED AND REMOVED FROM THE SITE IN ACCORD WITH SFD ADMINISTRATIVE RULE 34.02.04. SUCH WORK SHALL ONLY BE CONDUCTED BY A CERTIFIED UNDERGROUND STORAGE TANK DECOMMISSIONER, AND SUCH WORK REQUIRES A SEATTLE FIRE DEPARTMENT PERMIT. CALL 206-386-1025 FOR PERMIT INFORMATION.

WSEC SECTION R406.2

ADDITIONAL ENERGY EFFICIENCY REQUIREMENTS

- #I OR #3...... 3..5 CREDITS

 3. LARGE DWELLING UNIT: DWELLING UNITS OVER 5000SF IN

PROPOSED: OPTION

5c. EFFICIENCY WATER HEATING

CREDITS 1.5

....4.5 MIN CREDITS

5c. EFFICIENT WATER HEATING 5C:
WATER HEATING SYSTEM SHALL INCLUDE ONE OF THE FOLLOWING:
GAS, PROPANE OR OIL WATER HEATER WITH A MINIMUM EF OF O.91

WASHINGTON STATE ENERGY CODE NOTES:
BUILDING AIR LEAKAGE REQUIREMENTS TO

CONDITIONED FLOOR AREA

BUILDING AIR LEAKAGE REQUIREMENTS TO COMPLY WITH R402.4. DUCTS SHALL BE IN ACCORDANCE WITH R403.2. MINIMUM 75% OF ALL INTERIOR LAMPS SHALL BE HIGH EFFICACY LAMPS. ALL EXTERIOR LIGHTING SHALL BE HIGH EFFICACY LAMPS PER R404. A RESIDENTIAL ENERGY COMPLIANCE CERTIFICATE COMPLYING WITH R401.3 IS REQUIRED TO BE COMPLETED BY THE DESIGN PROFESSIONAL OR BUILDER AND PERMANENTLY POSTED WITHIN 3' OF THE ELECTRICAL PANEL PRIOR TO FINAL INSPECTION.

ARTIFICIAL LIGHT REQUIRED FOR HABITABLE ROOMS WITHOUT GLAZED AREAS PROVIDING NATURAL LIGHT PER SRC R303.1

EVERY DWELLING UNIT SHALL BE PROVIDED WITH AT LEAST ONE PROGRAMMABLE THERMOSTAT FOR THE REGULATION OF TEMPERATURE PER SRC R303.9

MIN. 7'-O" CEILING HEIGHT REQUIRED FOR HABITABLE ROOMS, HALLWAYS, CORRIDORS, BATHROOMS, TOILET ROOMS, LAUNDRY ROOMS AND BASEMENTS PER SECTION SRC R305

TOILET, BATH AND SHOWER SPACES PER SRC 307 & FIGURE SRC R307.I: PROVIDE MIN. 30" CLEAR WIDTH AND MIN. 21"CLEARANCE IN FRONT OF WATER CLOSET; I5" SEPARATION OF WATER CLOSET AND BATHTUB MEASURED FROM EDGE OF BATHTUB TO CL OF WATER CLOSET; AND, 4" SEPARATION FROM EDGE OF WATERCLOSET TO EDGE OF SINK. WALL COVERINGS SHALL BE A NONABSORBANT SURFACE. SUCH WALL SURFACE SHALL

EXTEND TO A HEIGHT OF NOT LESS THAN 6 FEET ABOVE DRAIN IN SHOWERS OR TUBS WITH SHOWERS PER SRC R307.2. SWING SHOWER

DOOR OUTWARD

GLASS ENCLOSURE DOORS & PANELS SHALL COMPLY WITH
TEST CRITERIA FOR CATEGORY II UNLESS OTHERWISE
INDICATED IN TABLE R308.3.I. SWING DOOR OUTWARD. SAFETY
GLAZING IS REQUIRED TO BE PERMANENTLY MARKED
PER SRC R308.I.

GARAGE SLAB SLOPE TO DRAIN TOWARDS GARAGE DOOR PER SRC R309.I

TYP. BEDROOM WINDOW TO COMPLY WITH SRC R310.
EMERGENCY EGRESS 5.7 SF MIN. NET CLEAR OPENING:
20 INCH MIN. CLEAR OPENING WIDTH,
24 INCH MIN. CLEAR OPENING HEIGHT,

AND 44 INCH MAX. SILL HEIGHT

SRC 310.1 - WHERE CASEMENT WINDOWS ARE USED FOR REQUIRED EGRESS, THE WINDOW SHOULD BE ALLOWED TO OPEN A MINIMUM OF 90 DEGREES FROM CLOSED POSITION AND IN OPEN POSITION SHALL NOT REDUCE THE REQUIRED WIDTH FOR EGRESS

ANY WINDOW WITH AN OPENING LOCATED 72" ABOVE FINISHED GRADE AND WITHIN 24" OF THE FINISHED FLOOR OF THE ROOM IT IS LOCATED SHALL BE FIXED OR HAVE OPENINGS LESS THAN 4 INCHES

STAIR WIDTHS AND HALLWAYS SHALL HAVE A MIN. CLEARANCE
OF 36" INCHES PER SRC R311.6 AND R311.7

THE MAXIMUM RISER HEIGHT SHALL BE 7 \(\frac{3}{4}\)". THE GREATEST RISER HEIGHT SHALL NOT EXCEED THE SMALLEST BY MORE THAN \(\frac{3}{6}\)" PER SRC R3II.7.5.I. THE MINIMUM TREAD DEPTH SHALL BE IO". THE GREATEST TREAD DEPTH SHALL NOT EXCEED THE SMALLEST BY \(\frac{3}{6}\)" PER SRC R3II.7.5.2. STAIR WINDERS SHALL HAVE A MIN. TREAD DEPTH OF 6" AT ANY POINT AND A MIN. TREAD DEPTH OF IO" MEASURED AT A POINT I2" FROM THE SIDE WHERE THE TREADS ARE NARROWER. THE GREATEST WINDER DEPTH AT THE I2" WALKLINE SHALL NOT EXCEED THE SMALLEST BY \(\frac{3}{6}\)" PER SRC R3II.7.5.2.I

STAIRWAYS SHALL BE ILLUMINATED & CONTROLLED BY SWITCHES LOCATED AT BOTH TOP AND BOTTOM OF STAIRS PER SRC R303.7

GAS FIREPLACE (DIRECT VENT) PROVIDE 6 SQ INCH OUTSIDE COMBUSTION AIR

PREFABRICATED FIREPLACE TO BE TESTED IN ACCORDANCE WITH UL 127 AND SHALL BE INSTALLED IN ACCORDANCE WITH THE TERMS OF THEIR LISTING AND THE MANUFACTURERS INSTRUCTIONS PER SRC RIOO4.

HEARTH TO BE CONSTRUCTED OF NON COMBUSTIBLE MATERIAL.
HEARTH EXTENSIONS SHALL EXTEND AT LEAST 16" IN FRONT
AND AT LEAST 8 INCHES BEYOND EACH SIDE OF FIREPLACE
OPENING. FOR FIREPLACE OPENINGS 6 SQUARE FEET OR LARGER
THE HEARTH EXTENSIONS SHALL EXTEND AT LEAST 20 INCHES
IN FRONT AND AT LEAST 12 INCHES BEYOND EACH SIDE OF THE
FIREPLACE OPENING PER SRC RIOOI.10

CLOTHES DRYER SHALL BE EXHAUSTED TO THE OUTSIDE OF THE BUILDING AND INDEPENDENT OF ALL OTHER EXHAUST SYSTEMS PER SRC MI502.2. THE CLOTHES DRYER EXHAUST DUCT SHALL NOT EXCEED 35' IN LENGTH FROM THE DRYER LOCATION TO THE EXTERIOR TERMINATION. THE MAX. DUCT LENGTH SHALL BE REDUCED BY 2.5 FT FOR EACH 45-DEGREE BEND AND 5 FT FOR EACH 90-DEGREE BEND PER TABLE MI502.4.4.1

WATER HEATERS SHALL BE INSTALLED IN ACCORDANCE WITH THE MANUFACTURERS INSTRUCTIONS PER SRC CHAP 20, 24\$28

FENESTRATION SCHEDULE - UNITS A1&A5 (PER UNIT)

LOCATION	SIZE	AREA	REMARKS	
FIRST FLOOR				
BEDROOM BEDROOM BEDROOM BEDROOM BEDROOM	(2)2650 2616 2616 2650 2616	25.0 3.75 3.75 12.5 3.75	FIXED FIXED	OM CASEMENT EGRESS OM CASEMENT EGRESS
SECOND FLOOR				
GREAT ROOM GREAT ROOM GREAT ROOM GREAT ROOM GREAT ROOM KITCHEN POWDER ROOM	2680 2680 2660 2616 5060 2646 2030	15.0 20.0 15.0 3.75 30.0 11.25 6.0		OM SLIDER OM CASEMENT
THIRD FLOOR				
MSTR BEDROOM MSTR BEDROOM MSTR BEDROOM MSTR BATHROOM MSTR BATHROOM STAIR LANDING	5046 (2)2666 2616 2030 2616 2868	22.5 32.5 3.75 6.0 3.75 17.77	TOP FIXED-BOTT FIXED FIXED SINGLE HUNG-SAF FIXED-SAFETY G DECK SMING DOO	,L
TOTAL GLAZING		236.02 5	F	
OPAQUE DOOR SC	HEDULE			
LOCATION	SIZE	MANUI	FACTURER #	REMARKS
FIRST FLOOR				
ENTRY	3068		CCVF050	THERMA-TRU FIBERGLASS


FENESTRATION SCHEDULE - UNITS A3&A4 (PER UNIT)

LOCATION	SIZE	AREA	A REMARKS	
FIRST FLOOR				
BATHROOM BATHROOM BEDROOM BEDROOM BEDROOM	2630 2630 2616 2650 2616	7.5 7.5 3.75 12.5 3.75	SINGLE HUNG-SAF FIXED-SAFETY G FIXED TOP FIXED-BOTT FIXED	
SECOND FLOOR				
GREAT ROOM GREAT ROOM GREAT ROOM GREAT ROOM KITCHEN POWDER ROOM	2680 (2)2680 2660 5060 2646 2030	15.0 40.0 15.0 30.0 11.25 6.0		OM CASEMENT
THIRD FLOOR				
MSTR BEDROOM MSTR BEDROOM MSTR BEDROOM MSTR BATHROOM MSTR BATHROOM STAIR LANDING	5046 (2)2666 2616 2030 2616 2868	22.5 32.5 3.75 6.0 3.75 17.77	TOP FIXED-BOTTO FIXED FIXED SINGLE HUNG-SAF FIXED-SAFETY G DECK SWING DOO	L
TOTAL GLAZING	l	238.52 5	F	
OPAQUE DOOR SCH	HEDULE			
LOCATION	SIZE	MANU	FACTURER #	REMARKS
FIRST FLOOR				
ENTRY	3068		CCVF050	THERMA-TRU FIBERGLASS

FENESTRATION SCHEDULE - UNIT A2:

LOCATION	SIZE	AREA	REMARKS)
FIRST FLOOR				
BATHROOM BEDROOM BEDROOM	2630 2650 2616	7.5 12.5 3.75	SINGLE HUNG-S TOP FIXED-BOT FIXED	AFETY GL ITOM CASEMENT EGRESS
SECOND FLOOR				
GREAT ROOM	(2)2680	40.0	TOP FIXED-MID	CASEMENT-BOTTOM FIXED SC
POWDER ROOM	2030	6.0	SINGLE HUNG-S	AFETY GL
THIRD FLOOR				
MSTR BEDROOM MSTR BEDROOM STAIR LANDING	5046 2666 2868	22.5 16.25 17.77	FIXED	ITOM SLIDER EGRESS OOR-SAFETY GL
TOTAL GLAZING		126.27 SF	=	
OPAQUE DOOR SC	HEDULE			
LOCATION	SIZE	MANU	FACTURER #	REMARKS
FIRST FLOOR				
ENTRY	3068		CCVF050	THERMA-TRU FIBERGLASS

ALL WINDOWS TO MEET NF	FRC CERTIFICATION REQUIREMENTS
HEATING	ELECTRIC
PRESCRIPTIVE OPTION	PER SEC R402.I.I
WINDOWS-VERTICAL	VINYL max. "∪" = .28
WINDOWS-OVERHEAD	max. "υ" = .50
DOORS(SOLID)	max. "∪" = .28
INSULATION VALUES	
ROOF- SOLID RAFTERS	REQ. R-38 MIN.
ROOF- OPEN TRUSSES	REQ. R-49 MIN.
WALLS	R-21
HEADERS	R-10
FLOOR	R-38
SLAB	R-10

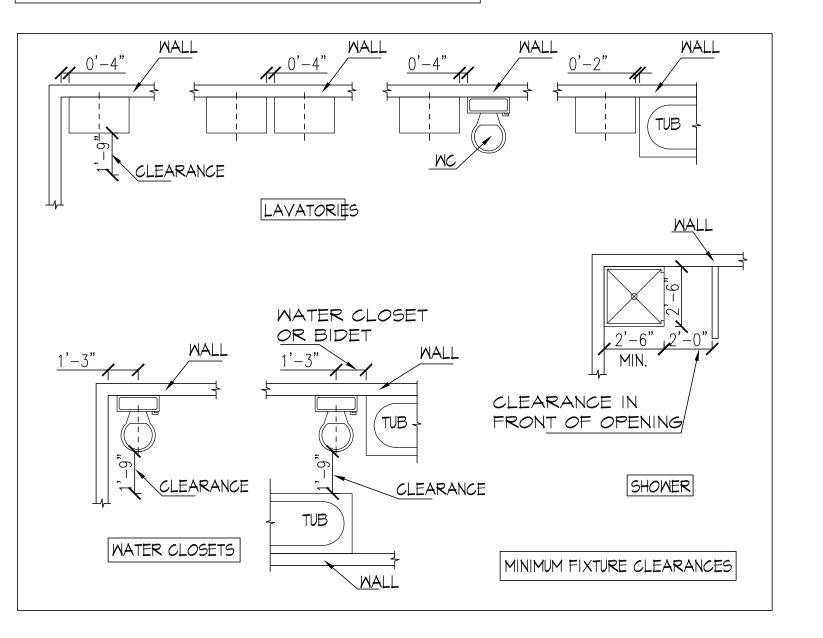

Date

Date |2/20|8

Scale

Drawn

SDCI#
3033303-LU \$ 6686871-CN

REGISTERED ARCHITECT

8634B 3RD AVE NW

SEATTLE WASH 98117

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PROJECT ADDRESS

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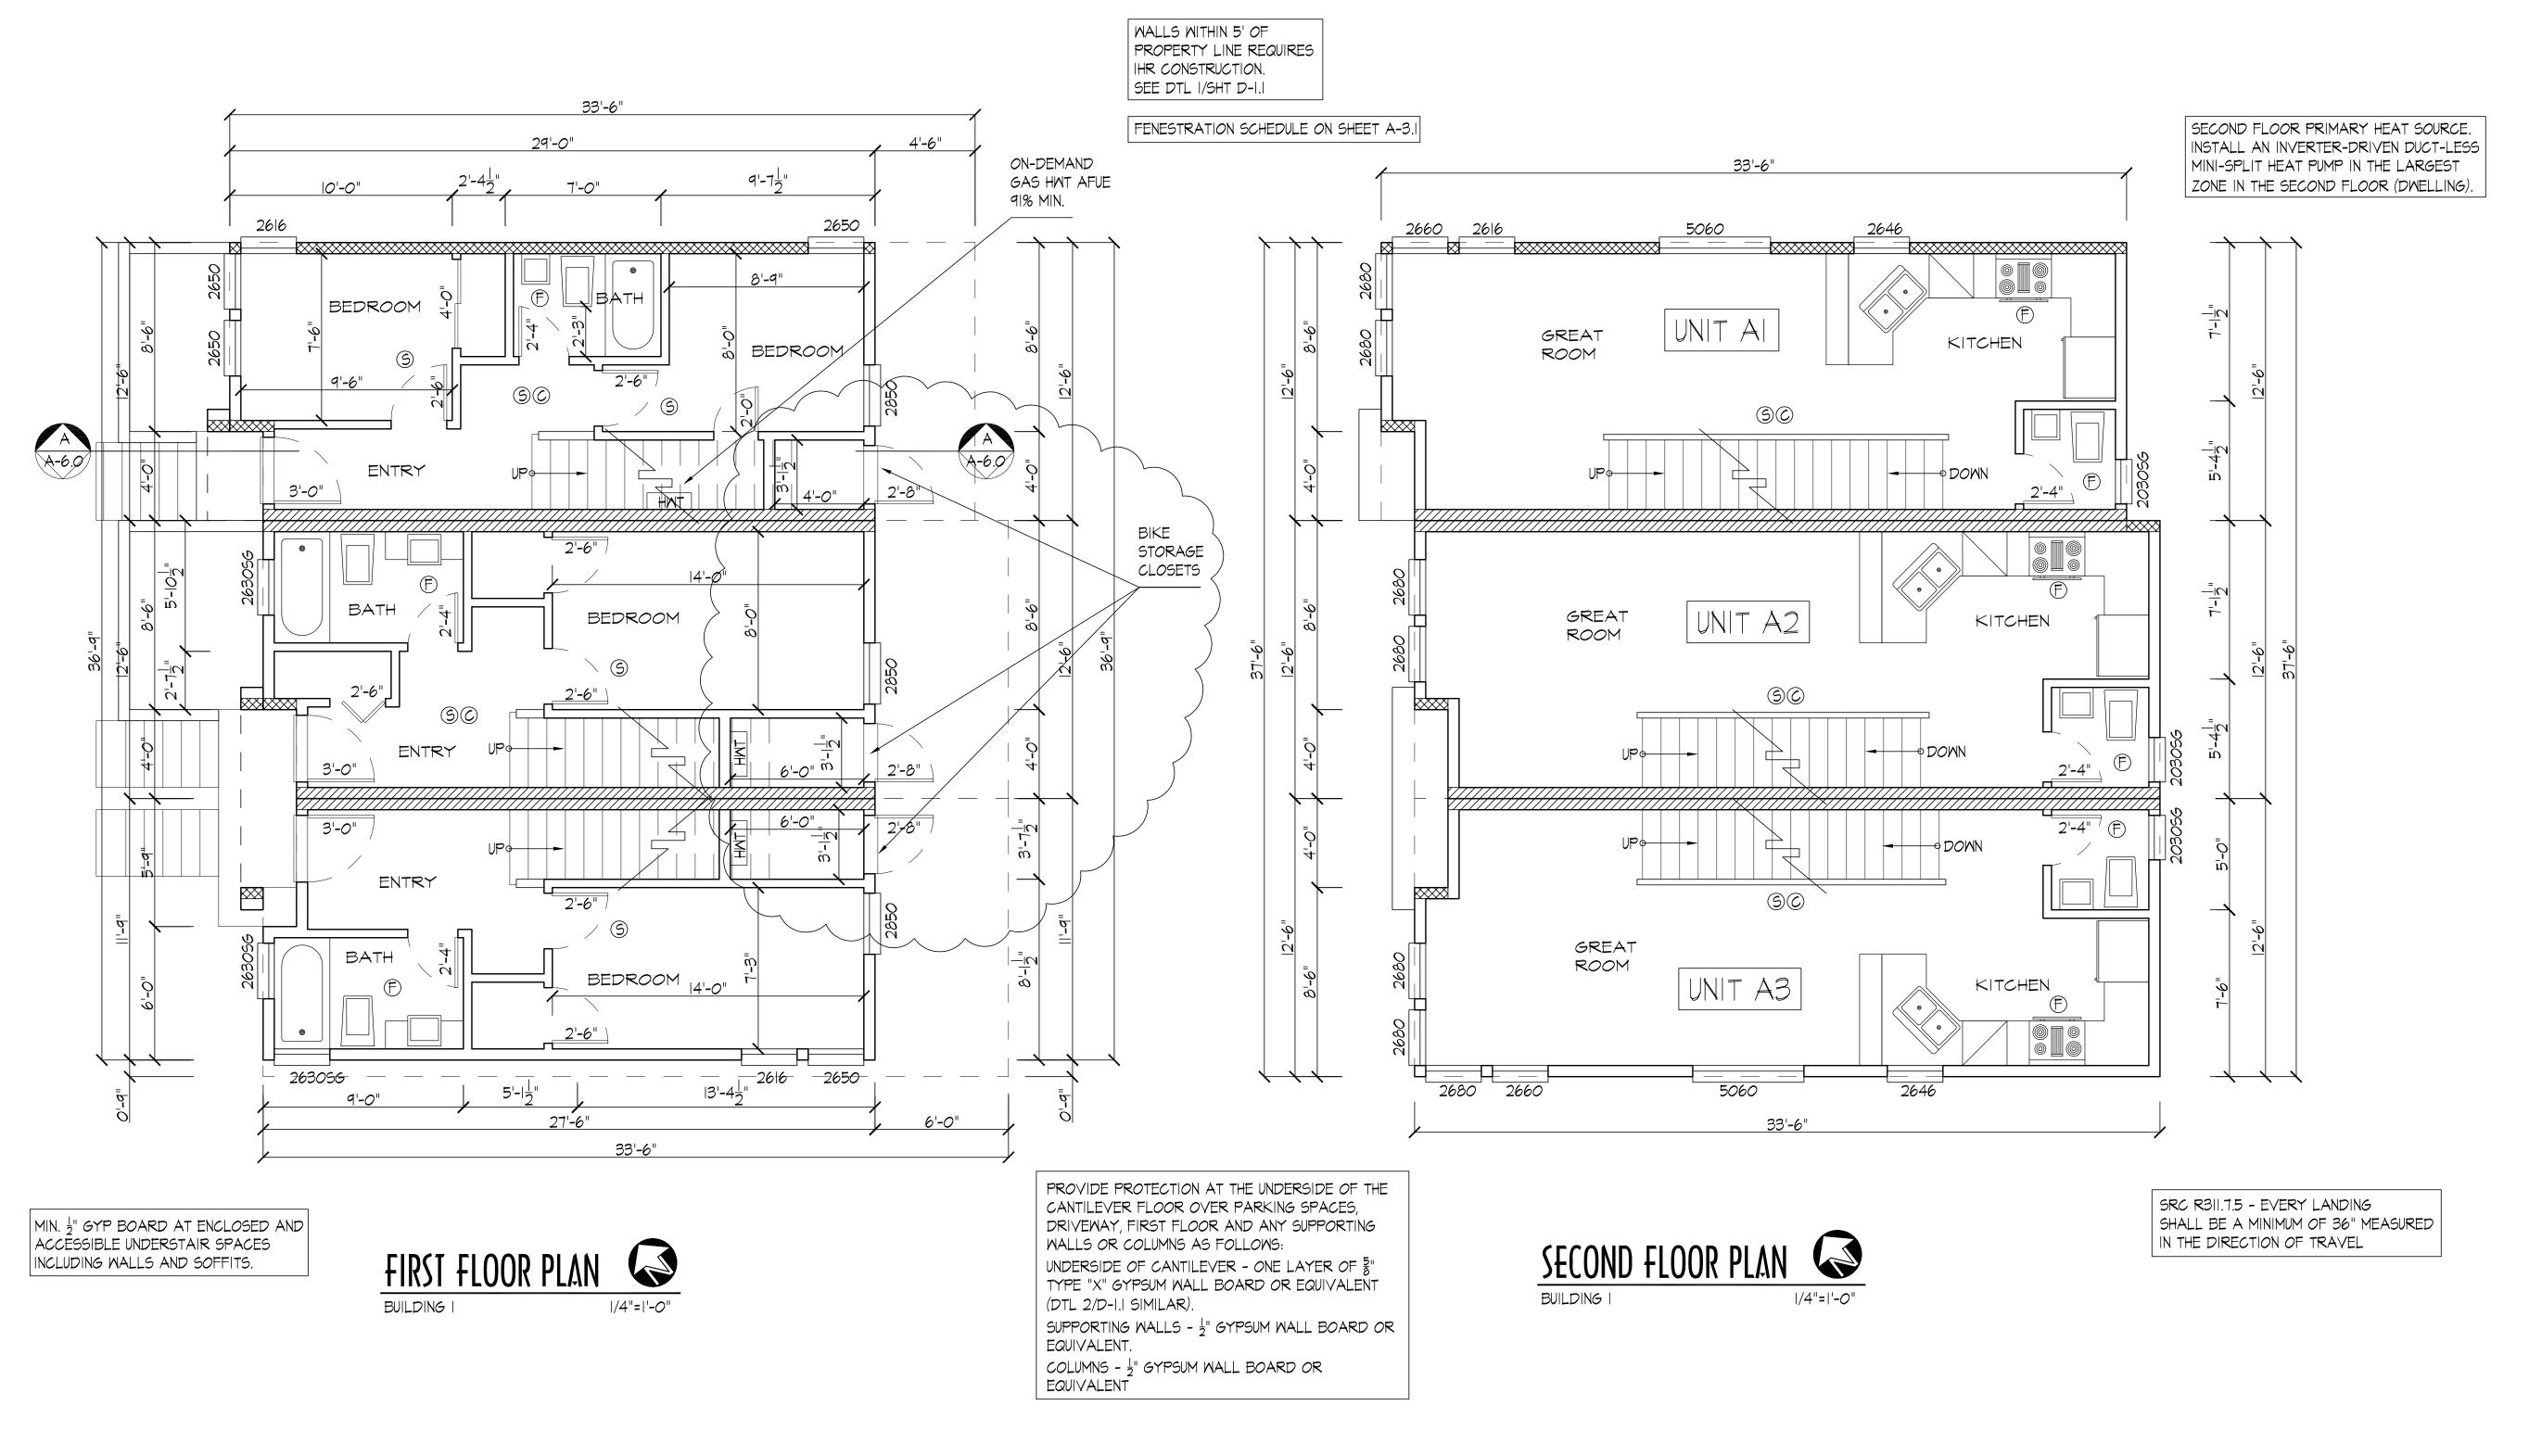
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APPROVAL STAMP

OWNER/CLIENT

Δ-3.1

City of Seattle
Department of Planning
Development
Issued for Permit



(S) SMOKE DETECTOR 110 VOLT- INTERCONNECTED-BATTERY BACKUP C CARBON MONOXIDE ALARM COMPLY WITH UL 2034 - INSTALL PER MANUF RECOMMENDATIONS (F) EXAUST FAN ALL EXHAUST FANS TO COMPLY WITH SRC CHPT 15 FAN CAPABLE OF FIVE AIR CHANGES PER HOUR. VENT DIRECTLY TO EXTERIOR THROUGH SMOOTH RIGID NON ABSORBENT DUCTS. 5' MINIMUM DISTANCE FROM VENT WINDOW. KITCHEN 100 CFM MIN. INTERMITENT OPERATION, BATHROOM 50 CFM MIN. INTERMITTENT OPERATION, EXHAUST DUCTS SHALL TERMINATE OUTSIDE THE BUILDING AND SHALL BE EQUIPPED WITH BACKDRAFT DAMPERS. F WHOLE HOUSE FAN ALL VENTILATION MUST COMPLY WITH THE 2015 SEATTLE RESIDENTIAL CODE. SRC MI507.3 PRESCRIPTIVE METHOD-TABLE 1507.3.3(1). 3 BEDROOM-AND AS AMENDED BY TABLE M1507.3.3(2)-SYSTEM DESIGNED TO OPERATE CONTINUOUSLY. 45 CFM MIN. REQUIRED. PROPOSED 50 CFM PANASONIC WHISPERGREEN FV-05-11VK2. 1.0 MAX SONE RATING AT O.I" WATER GAUGE-.03 SONES ACTUAL TESTED. INTEGRATED SYSTEM-FRESH AIR SUPPLY THROUGH WINDOW PORT. PER SRC MI507.3.4.4 EACH HABITABLE SPACE TO HAVE AT LEAST ONE WINDOW WITH A WINDOW PORT. WALL- ONE HOUR RATED EXTERIOR WALL- SEE DETAIL I/D-I.I WALL- TWO I-HOUR RATED PARTY WALL- SEE DETAIL 3\$4/D-I.I WALL- TWO I-HOUR RATED PARAPET WALL- SEE DETAIL 9/D-1.0

ALL WINDOWS TO MEET NFRC CERTIFICATION REQUIREMENTS HEATING ELECTRIC PRESCRIPTIVE OPTION PER SEC R402.1.1 VINYL max. "u" = .28 WINDOWS-VERTICAL WINDOWS-OVERHEAD max. "u" = .50 max. "u" = .28 DOORS(SOLID) INSULATION VALUES ROOF- SOLID RAFTERS REQ. R-38 MIN. REQ. R-49 MIN. ROOF- OPEN TRUSSES WALLS R-21 HEADERS R-10 FLOOR R-38 SLAB R-10

STUDS:	
EXTERIOR WALLS	2X6'S U.N.O.
INTERIOR WALL (GARAGE) TO UNHE	ATED 2X6'S
INTERIOR WALL - NON BEARING	2X4'S
INTERIOR WALL - PLUMBING WALL	2X6'S
INTERIOR WALL - BEARING	3X4'S @ FIRST FLOOR
	2X4'S @ OTHER FLOORS

SEC R402.4.1.2 - AIR LEAKAGE SHALL NOT EXCEED 5 AIR CHANGES/HOUR AND SHALL BE TESTED AS SUCH. A WRITTEN REPORT OF THE TEST RESULTS, SHALL BE SIGNED BY THE TESTING PARTY AND PROVIDED TO THE BUILDING INSPECTOR, PRIOR TO CALL FOR FINAL INSPECTION.



REGISTERED ARCHITECT

RODRIGO E. NOVION STATE OF WASHINGTON

NOVION GROUP INC.

MUP CORR-1

SN 10/2019

8634B 3RD AVE NW SEATTLE WASH 98117 PH(206)361.6133FAX361.6345

PROJECT ADDRESS

38 SAND POINT PL. NE ATTLE, MA

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ARN HOMES LLO 1556 IZTH AVE NE 3EATTLE, MA 98115 9H: 206-985-0212

APPROVAL STAMP

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SDCI #
3033303-LU \$ 6686871-CN

∆-4.0

SRC R311.7.5 - EVERY LANDING SHALL BE A MINIMUM OF 36" MEASURED IN THE DIRECTION OF TRAVEL

33'-6" 29'-10¹ 6'-107" 11'-105" 6'-0" MASTER SUITE 2'-6" - DOWN MASTER SUITE 2'-6" 2'-6" MASTER 2666 6'-10¹ ||'-|0|" 4'-0" 3'-7-5" 29'-10=" THIRD FLOOR PRIMARY HEAT SOURCE.

SLOPE ROOF DECK TO DRAIN 4" PER FOOT TO GUTTER. DIRECT DOWNSPOUTS TO BIO-RETENTION PLANTERS. ROUTE THRU CATCH BASIN, PRIOR TO CONNECTION TO THE APPROVED DISCHARGE POINT CURB WEEP HOLE

- UNVENTED ROOF ASSEMBLY SPRAY FOAM REPORT ESR-2642. - A COPY OF THE ICC ESR REPORT FOR THE PRODUCT USED MUST BE PROVIDED ON JOB SITE FOR FIELD INSPECTOR VERIFICATION. - APPLIED SPRAY FOAM MUST BE INSTALLED BY A CERTIFIED INSPECTOR

ROOF DECK SLOPE 1/2" PER FOOT FOR DRAINAGE ROOF UNIT A2 SLOPE | 1 PER FOOT FOR DRAINAGE DOWN -SLOPE 4" PER FOOT FOR DRAINAGE DECK

WALLS WITHIN 5' OF PROPERTY LINE REQUIRES IHR CONSTRUCTION. SEE DTL I/SHT D-1.1

> NO VENTILATION ALLOWED IN EAST PARAPET CLOSER THAN 5'

TO PROPERTY LINE.

SRC TABLE 302.1 - I-HR PARAPETS WITHIN 5' OF A PROPERTY LINE. SEE DTL 4/D-1.0

ROOF DECK PLAN

BUILDING I

|/4"=|'-0"

NO STORAGE OR USABLE SPACE IS PERMITTED IN THE PENTHOUSE ENCLOSURE BEYOND THAT REQUIRED FOR CIRCULATION

PER APPENDIX U OF THE 2015 RESIDENTIAL CODE, SECTION UIOI.I EXCEPTION I, IF THE QUALIFYING ROOF AREA IS LESS THAN 300SF SOLAR READY ZONES ARE NOT REQUIRED.

33'-6"

(5) SMOKE DETECTOR 110 VOLT- INTERCONNECTED-BATTERY BACKUP C CARBON MONOXIDE ALARM COMPLY WITH UL 2034 - INSTALL PER MANUF RECOMMENDATIONS

INSTALL AN INVERTER-DRIVEN DUCT-LESS

MINI-SPLIT HEAT PUMP IN THE LARGEST

ZONE IN THE THIRD FLOOR (DWELLING).

F EXAUST FAN ALL EXHAUST FANS TO COMPLY WITH SRC CHPT 15

FAN CAPABLE OF FIVE AIR CHANGES PER HOUR. VENT DIRECTLY TO EXTERIOR THROUGH SMOOTH RIGID NON ABSORBENT DUCTS. 5' MINIMUM DISTANCE FROM VENT WINDOW. KITCHEN 100 CFM MIN. INTERMITENT OPERATION, BATHROOM 50 CFM MIN. INTERMITTENT OPERATION, EXHAUST DUCTS SHALL TERMINATE OUTSIDE THE BUILDING AND SHALL BE EQUIPPED WITH BACKDRAFT DAMPERS.

PER SRC MI507.3.4.4 EACH HABITABLE SPACE TO HAVE AT LEAST ONE WINDOW WITH A WINDOW PORT.

ALL VENTILATION MUST COMPLY WITH THE 2015 SEATTLE RESIDENTIAL CODE. SRC M1507.3 F WHOLE HOUSE FAN

PRESCRIPTIVE METHOD-TABLE 1507.3.3(1). 3 BEDROOM-AND AS AMENDED BY TABLE MI507.3.3(2)-SYSTEM DESIGNED TO OPERATE CONTINUOUSLY. 45 CFM MIN. REQUIRED. PROPOSED 50 CFM PANASONIC WHISPERGREEN FV-05-IIVK2. I.O MAX SONE RATING AT O.I" WATER GAUGE-.03 SONES ACTUAL TESTED. INTEGRATED SYSTEM-FRESH AIR SUPPLY THROUGH WINDOW PORT.

WALL- ONE HOUR RATED EXTERIOR WALL- SEE DETAIL I/D-I.I

MALL- TWO I-HOUR RATED PARTY WALL- SEE DETAIL 3\$4/D-I.I

WALL- TWO I-HOUR RATED PARAPET WALL- SEE DETAIL 9/D-I.O

ALL WINDOWS TO MEET NFRC CERTIFICATION REQUIREMENTS HEATING ELECTRIC PRESCRIPTIVE OPTION PER SEC R402.I.I WINDOWS-VERTICAL VINYL max. "u" = .28 WINDOWS-OVERHEAD max. "u" = .50 DOORS(SOLID) max. "u" = .28 INSULATION VALUES

R-10

ROOF- SOLID RAFTERS REQ. R-38 MIN. ROOF- OPEN TRUSSES REQ. R-49 MIN. WALLS R-21 HEADERS R-10 FLOOR R-38

SLAB

STUDS:	
EXTERIOR WALLS	2X6'5 U.N.O.
INTERIOR WALL (GARAGE) TO UNHEA	ATED 2X6'S
INTERIOR WALL - NON BEARING	2X4'S
INTERIOR WALL - PLUMBING WALL	2X6'S
INTERIOR WALL - BEARING	3X4'S @ FIRST FLOOR
	2X4'S @ OTHER FLOORS

SEC R402.4.1.2 - AIR LEAKAGE SHALL NOT EXCEED 5 AIR CHANGES/HOUR AND SHALL BE TESTED AS SUCH. A WRITTEN REPORT OF THE TEST RESULTS, SHALL BE SIGNED BY THE TESTING PARTY AND PROVIDED TO THE BUILDING INSPECTOR, PRIOR TO CALL FOR FINAL INSPECTION.



02/11/2020 3033303-LU \$ 6686871-CN

∆-4.7

12/2018

1/4"=1' 0"

Rn Sn

SN 10/2019

REGISTERED ARCHITECT

RODRIGO E. NOVION STATE OF WASHINGTON

8634B 3RD AVE NW SEATTLE WASH 98117

PH(206)361.6133FAX361.6345

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OWNER/CLIENT


PROJECT ADDRESS

MUP CORR-1

APPROVAL STAMP



SECOND FLOOR PRIMARY HEAT SOURCE.
INSTALL AN INVERTER-DRIVEN DUCT-LESS
MINI-SPLIT HEAT PUMP IN THE LARGEST
ZONE IN THE SECOND FLOOR (DWELLING).

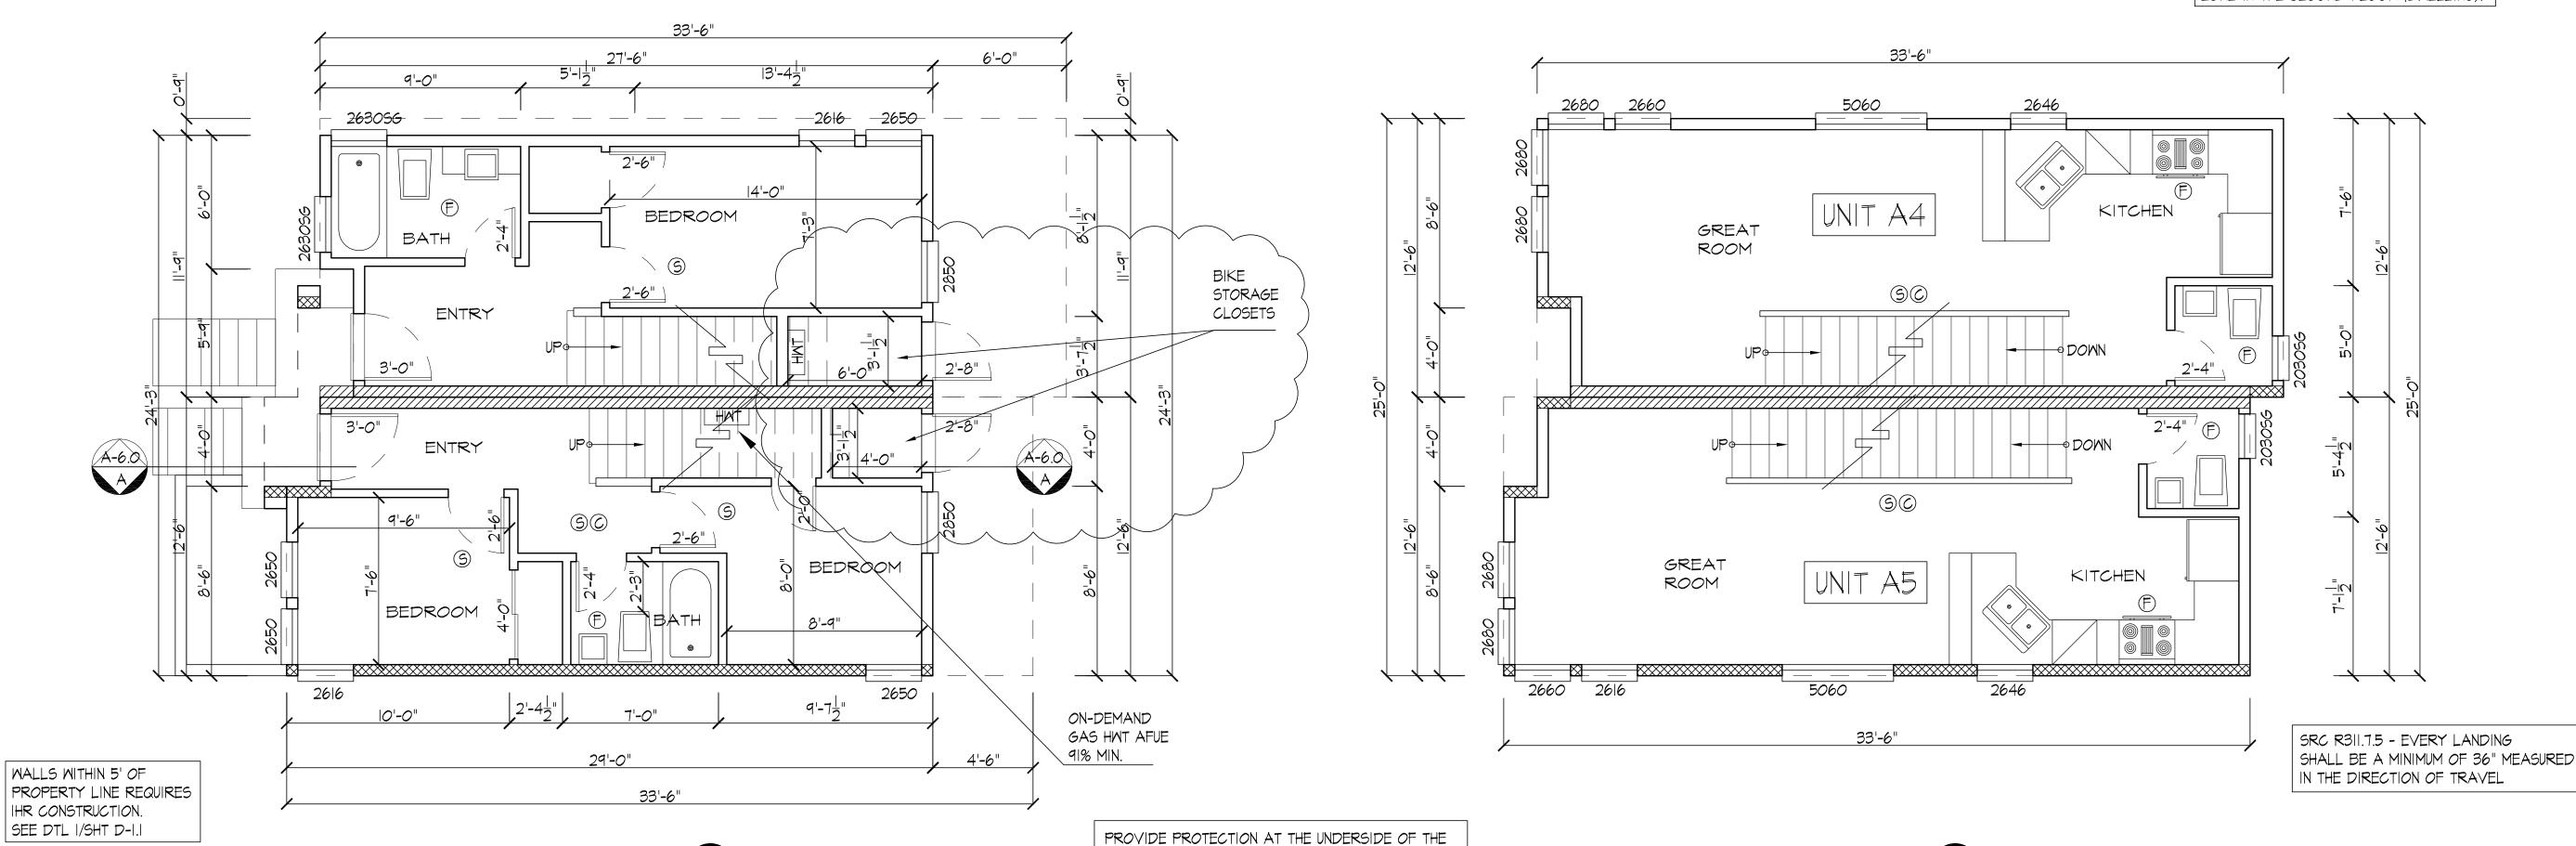

CANTILEVER FLOOR OVER PARKING SPACES,

WALLS OR COLUMNS AS FOLLOWS:

(DTL 2/D-I.I SIMILAR).

EQUIVALENT.

EQUIVALENT

DRIVEWAY, FIRST FLOOR AND ANY SUPPORTING

UNDERSIDE OF CANTILEVER - ONE LAYER OF &"

TYPE "X" GYPSUM WALL BOARD OR EQUIVALENT

SUPPORTING WALLS - $\frac{1}{2}$ GYPSUM WALL BOARD OR

COLUMNS - $\frac{1}{2}$ GYPSUM WALL BOARD OR

(S) SMOKE DETECTOR 110 VOLT- INTERCONNECTED-BATTERY BACKUP © CARBON MONOXIDE ALARM COMPLY WITH UL 2034 - INSTALL PER MANUF RECOMMENDATIONS (F) EXAUST FAN ALL EXHAUST FANS TO COMPLY WITH SRC CHPT 15 FAN CAPABLE OF FIVE AIR CHANGES PER HOUR. VENT DIRECTLY TO EXTERIOR THROUGH SMOOTH RIGID NON ABSORBENT DUCTS. 5' MINIMUM DISTANCE FROM VENT WINDOW. KITCHEN 100 CFM MIN. INTERMITENT OPERATION, BATHROOM 50 CFM MIN. INTERMITTENT OPERATION, EXHAUST DUCTS SHALL TERMINATE OUTSIDE THE BUILDING AND SHALL BE EQUIPPED WITH BACKDRAFT DAMPERS. (F) WHOLE HOUSE FAN ALL VENTILATION MUST COMPLY WITH THE 2015 SEATTLE RESIDENTIAL CODE. SRC MI507.3 PRESCRIPTIVE METHOD-TABLE 1507.3.3(1). 3 BEDROOM-AND AS AMENDED BY TABLE MI507.3.3(2)-SYSTEM DESIGNED TO OPERATE CONTINUOUSLY. 45 CFM MIN. REQUIRED. PROPOSED 50 CFM PANASONIC WHISPERGREEN FV-05-11VK2. 1.0 MAX SONE RATING AT O.I" WATER GAUGE-.03 SONES ACTUAL TESTED. INTEGRATED SYSTEM-FRESH AIR SUPPLY THROUGH WINDOW PORT. PER SRC MI507.3.4.4 EACH HABITABLE SPACE TO HAVE AT LEAST ONE WINDOW WITH A WINDOW PORT. WALL- ONE HOUR RATED EXTERIOR WALL- SEE DETAIL I/D-I.I MALL- TWO I-HOUR RATED PARTY WALL- SEE DETAIL 3\$4/D-I.I

WALL- TWO I-HOUR RATED PARAPET WALL- SEE DETAIL 9/D-I.O

|/4"=|'-0"

FIRST FLOOR PLAN

BUILDING 2

FENESTRATION SCHEDULE ON SHEET A-3.1

ALL WINDOWS TO MEET NFRC CERTIFICATION REQUIREMENTS HEATING ELECTRIC PRESCRIPTIVE OPTION PER SEC R402.1.1 WINDOWS-VERTICAL VINYL max. "u" = .28 WINDOWS-OVERHEAD max. "u" = .50 DOORS(SOLID) max. "v" = .28 INSULATION VALUES ROOF- SOLID RAFTERS REQ. R-38 MIN. ROOF- OPEN TRUSSES REQ. R-49 MIN. WALLS R-21 HEADERS R-10 FLOOR R-38 SLAB R-10

SECOND FLOOR PLAN

|/4"=|'-0"

BUILDING 2

STUDS:	
EXTERIOR WALLS	2X6'S U.N.O.
INTERIOR WALL (GARAGE) TO UNHE	ATED 2X6'S
INTERIOR WALL - NON BEARING	2X4'S
INTERIOR WALL - PLUMBING WALL	2X6'S
INTERIOR WALL - BEARING	3X4'S @ FIRST FLOOR
	2X4'S @ OTHER FLOORS

SEC R402.4.1.2 - AIR LEAKAGE SHALL NOT EXCEED 5 AIR CHANGES/HOUR AND SHALL BE TESTED AS SUCH. A WRITTEN REPORT OF THE TEST RESULTS, SHALL BE SIGNED BY THE TESTING PARTY AND PROVIDED TO THE BUILDING INSPECTOR, PRIOR TO CALL FOR FINAL INSPECTION.



Date |2/20|8
| Scale | 1/4"=1' 0"
| Drawn | Rn Sn

SDCI # 3033303-LU \$ 668687I-CN Sheet

Δ-5.0

DATE SN 10/2019

REGISTERED ARCHITECT

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OMES LLC 2TH AVE NE -E, NA 90||5 06-905-02|2


APPROVAL STAMP

OWNER/CLIENT

PROJECT ADDRESS


MUP CORR-1

SRC R311.7.5 - EVERY LANDING SHALL BE A MINIMUM OF 36" MEASURED IN THE DIRECTION OF TRAVEL

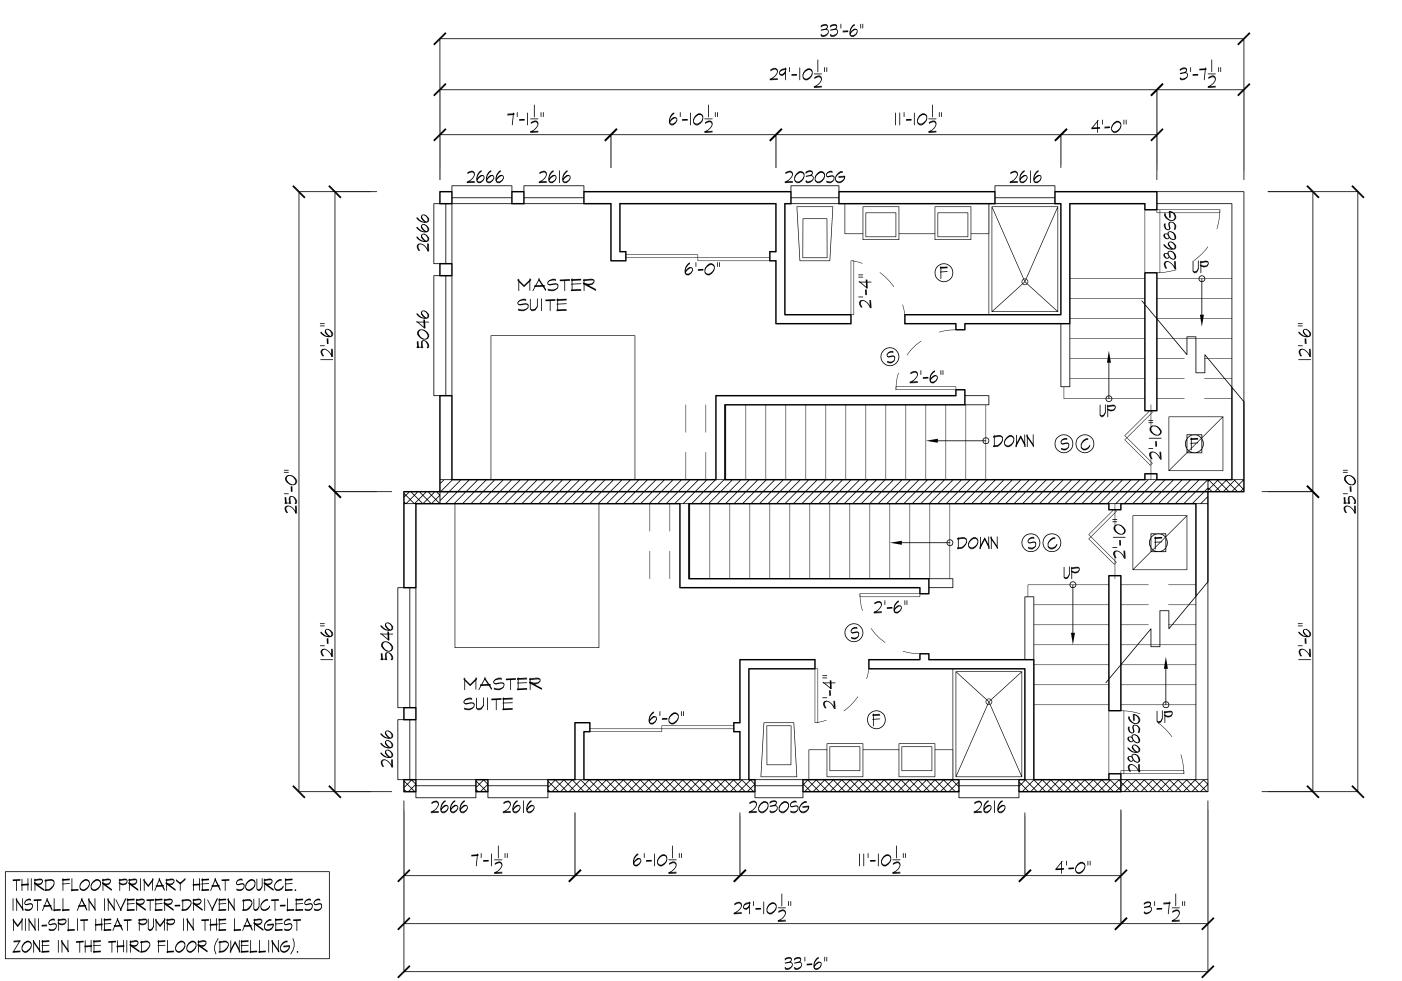

SLOPE ROOF DECK TO DRAIN 4"
PER FOOT TO GUTTER. DIRECT
DOWNSPOUTS TO BIO-RETENTION
PLANTERS. ROUTE THRU CATCH
BASIN, PRIOR TO CONNECTION TO
THE APPROVED DISCHARGE POINT:
CURB WEEP HOLE

- UNVENTED ROOF ASSEMBLY SPRAY FOAM REPORT ESR-2642.
- A COPY OF THE ICC ESR REPORT FOR THE PRODUCT USED MUST BE PROVIDED ON JOB SITE FOR FIELD INSPECTOR VERIFICATION.
- APPLIED SPRAY FOAM MUST BE INSTALLED BY A CERTIFIED INSPECTOR

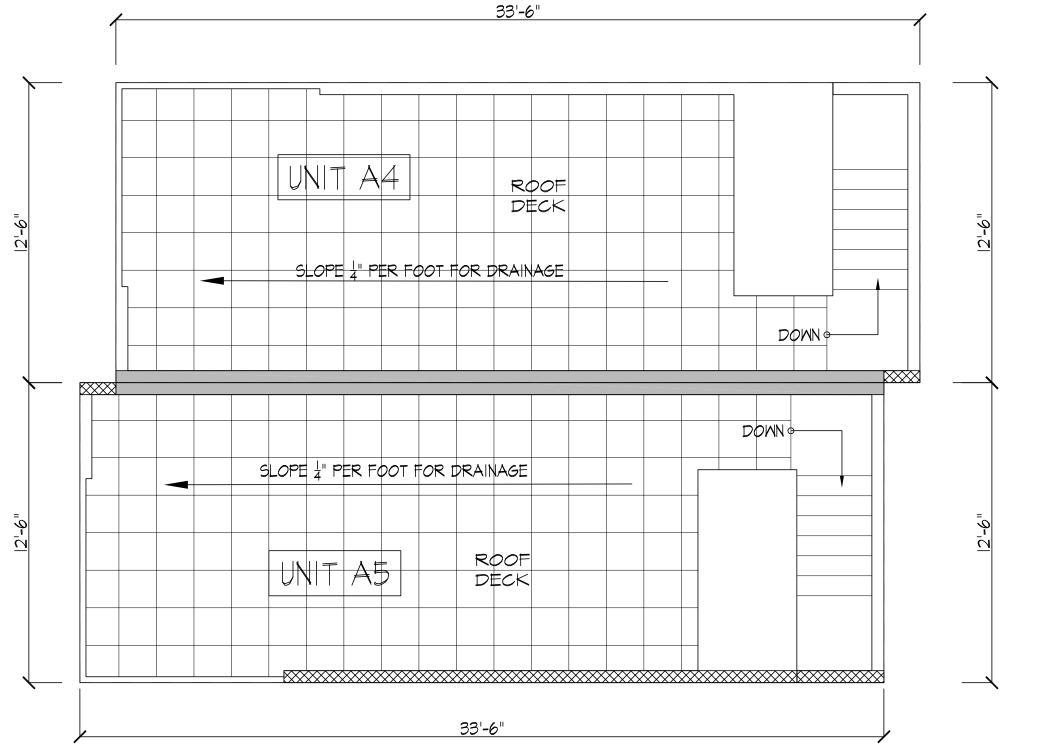

WALLS WITHIN 5' OF PROPERTY LINE REQUIRES IHR CONSTRUCTION.
SEE DTL 1/SHT D-1.1

NO VENTILATION ALLOWED IN EAST PARAPET CLOSER THAN 5'

TO PROPERTY LINE.

SRC TABLE 302.1 - I-HR
PARAPETS WITHIN 5' OF A
PROPERTY LINE. SEE DTL 4/D-I.0

ROOF DECK PLAN
BUILDING 2

|/4"=|'-O"

NO STORAGE OR USABLE SPACE IS PERMITTED IN THE PENTHOUSE ENCLOSURE BEYOND THAT REQUIRED FOR CIRCULATION

PER APPENDIX U OF THE 2015 RESIDENTIAL CODE, SECTION UIOI.I EXCEPTION I, IF THE QUALIFYING ROOF AREA IS LESS THAN 300SF, SOLAR READY ZONES ARE NOT REQUIRED.

S SMOKE DETECTOR 110 VOLT- INTERCONNECTED-BATTERY BACKUP © CARBON MONOXIDE ALARM COMPLY WITH UL 2034 - INSTALL PER MANUF RECOMMENDATIONS (F) EXAUST FAN ALL EXHAUST FANS TO COMPLY WITH SRC CHPT 15 FAN CAPABLE OF FIVE AIR CHANGES PER HOUR. VENT DIRECTLY TO EXTERIOR THROUGH SMOOTH RIGID NON ABSORBENT DUCTS. 5' MINIMUM DISTANCE FROM VENT WINDOW. KITCHEN 100 CFM MIN. INTERMITENT OPERATION, BATHROOM 50 CFM MIN. INTERMITTENT OPERATION, EXHAUST DUCTS SHALL TERMINATE OUTSIDE THE BUILDING AND SHALL BE EQUIPPED WITH BACKDRAFT DAMPERS. (F) WHOLE HOUSE FAN ALL VENTILATION MUST COMPLY WITH THE 2015 SEATTLE RESIDENTIAL CODE. SRC MI507.3 PRESCRIPTIVE METHOD-TABLE 1507.3.3(1). 3 BEDROOM-AND AS AMENDED BY TABLE M1507.3.3(2)-SYSTEM DESIGNED TO OPERATE CONTINUOUSLY. 45 CFM MIN. REQUIRED. PROPOSED 50 CFM PANASONIC WHISPERGREEN FV-05-IIVK2. I.O MAX SONE RATING AT O.I" WATER GAUGE-.03 SONES ACTUAL TESTED. INTEGRATED SYSTEM-FRESH AIR SUPPLY THROUGH WINDOW PORT. PER SRC MI507.3.4.4 EACH HABITABLE SPACE TO HAVE AT LEAST ONE WINDOW WITH A WINDOW PORT. WALL- ONE HOUR RATED EXTERIOR WALL- SEE DETAIL I/D-I.I MALL- TWO I-HOUR RATED PARTY WALL- SEE DETAIL 3\$4/D-I.I WALL- TWO I-HOUR RATED PARAPET WALL- SEE DETAIL 9/D-I.O

ALL WINDOWS TO MEET NFRC CERTIFICATION REQUIREMENTS HEATING ELECTRIC PRESCRIPTIVE OPTION PER SEC R402.I.I VINYL max. "u" = .28 WINDOWS-VERTICAL WINDOWS-OVERHEAD max. "u" = .50 DOORS(SOLID) max. "v" = .28 INSULATION VALUES ROOF- SOLID RAFTERS REQ. R-38 MIN. ROOF- OPEN TRUSSES REQ. R-49 MIN. WALLS R-21 HEADERS R-10 R-38 FLOOR

R-10

SLAB

STUDS:	
EXTERIOR WALLS	2X6'S U.N.O.
INTERIOR WALL (GARAGE) TO UNHE	ATED 2X6'S
INTERIOR WALL - NON BEARING	2X4'S
INTERIOR WALL - PLUMBING WALL	2X6'5
INTERIOR WALL - BEARING	3X4'S @ FIRST FLOOR
	2X4'S @ OTHER FLOORS

SEC R402.4.1.2 - AIR LEAKAGE SHALL NOT EXCEED 5 AIR CHANGES/HOUR AND SHALL BE TESTED AS SUCH. A WRITTEN REPORT OF THE TEST RESULTS, SHALL BE SIGNED BY THE TESTING PARTY AND PROVIDED TO THE BUILDING INSPECTOR, PRIOR TO CALL FOR FINAL INSPECTION.



RODRIGO E. NOVION STATE OF WASHINGTON

NOVION GROUP
INC.

MUP CORR-1

SN 10/2019

8634B 3RD AVE NW SEATTLE WASH 98117 PH(206)361.6133FAX361.6345

PROJECT ADDRESS

O38 SAND POINT PL. NE EATTLE, MA

OWNER/CLIENT

VRN HOMES LLO 1556 | 2TH AVE NE 5EATTLE, MA 98||5 7H: 206-985-02|2

APPROVAL STAMP

12/2018

3033303-LU \$ 668687I-CN

Δ-5.1





DESIGN STANDARDS FOR STREET FACING FACADES:

SMC 23.45.529.C.I FACADE OPENINGS - AT LEAST 20% OF THE AREA OF EACH STREET FACING FACADE SHALL CONSIST OF WINDOWS AND/OR DOORS. WE'RE PROPOSING 25.7% OF THE STREET FACING FACADE CONSIST OF TRANSPARENT WINDOWS AND DOORS.

SMC 23.45.529.C.3.d FACADE ARTICULATION - REQUESTING FACADE ARTICULATION REQUIREMENT BE MET BASED ON SPECIAL TREATMENT OF FENESTRATION. OUR FACADE OPENING TOTAL IS OVER 25%, OF THE STREET FACING FACADE.

SMC 23.45.529.E.I PEDESTRIAN ENTRY - EACH UNIT WILL HAVE A PEDESTRIAN ENTRY ON THE STREET FACING FACADE.

SMC 23.45.529.E.2 FRONT SETBACK - LANDSCAPING PROPOSED BETWEEN THE STREET AND THE ROWHOUSE UNITS (REFER TO LANDSCAPE PLANS FOR MORE DETAIL)

SMC 23.45.529.E.3 ARCHITECTURAL EXPRESSION - UNITS INDIVIDUALLY IDENTIFIED BY A TRANSITION IN MATERIAL AND MODULATION OF ARCHITECTURAL FEATURES.

DESIGN STANDARDS FOR THE STREET FACING FACADES:

STREET FACING FACADE TOTAL (BOTH BUILDINGS) - 1,811.875 SF SMC 23.45.529.C.I FACADE OPENINGS:

TOTAL TRANSPARENT GLASS (BOTH BUILDINGS) - 466.25 SF 466.25/1811.875 = 25.7%: FACADE OPENING CALCULATION -

City of Seattle
Department of Planning
Development
Issued for Page

Δ-5.3

MUP CORR-1

8634B 3RD AVE NW SEATTLE WASH 98117 PH(206)361.6133FAX361.6345 PROJECT ADDRESS

> S II O III

OWNER/CLIENT

OMES LLC 2TH AVE NE LE, MA 90115 06-905-0212

APPROVAL STAMP

1/4"=1' 0"

Rn Sn

3033303-LU \$ 6686871-CN

PLANT SCHEDULE



FOR EACH HATCH AREA PROVIDE AMOUNT OF PLANTINGS LISTED ADJACENT TO HATCH

* SHRUB WITH A MATURE HEIGHT OF 24" OR GREATER, (FOR GREEN FACTOR CALCULATIONS)

PLANT SHRUBS AND GROUNDCOVERS A MINIMUM OF 18" FROM PAVED SURFACES

DROUGHT TOLERANT SHRUB OR GROUNDCOVER, ONCE ESTABLISHED, NOTE SOME SPECIES ARE DRAUGHT TOLERANT WHEN GROWN IN SHADE AS THEY ARE ON THIS PLAN

SEE ARCHITECTURAL PLANS FOR ALL RAILS AND RAILINGS

COORDINATE ALL WORK WITH ARCHITECTURAL AND CIVIL DRAWINGS.

COORDINATE TREE LOCATIONS WITH UTILITY PLANS, TREES MUST BE 5' MINIMUM HORIZONTAL DISTANCE FROM UNDERGROUND UTILITIES. COORDINATE WITH OWNER AND LANDSCAPE ARCHITECT IF TREES NEED TO BE LOCATED SUBSTANTIAL DIFFERENT FROM LOCATIONS AS SHOWN ON PLANS.

CONTACT SDOT URBAN FORESTRY (206-684-5693) TO COORDINATE STREET TREE SELECTION, AS WELL AS ANY OTHER WORK IN THE RIGHT OF WAY *BEFORE* WORK COMMENCES ON-SITE. ALSO CONTACT URBAN FORESTRY FOR INSPECTION AND APPROVAL OF NEW STREET TREES. STREET TREE VARIETY APPROVED BY BEN ROBERTS 12-12-2018

REMOVE EXISTING 8" CALIPER PINE TREE ADJACENT TO SIDEWALK, TREE REMOVAL REQUIRES A SEPARATE SDOT PERMIT AND THE TREES NEED TO BE POSTED WITH A REMOVAL NOTICE FOR A MINIMUM OF 14-DAYS BEFORE THE PERMIT CAN BE ISSUED. CONTACT BEN ROBERTS, SDOT URBAN FORESTRY.

PERVIOUS PAVING, WITH A TOTAL OF OVER 24" OF GRAVEL AND SOIL BENEATH, MUST MEET SEATTLE PUBLIC UTILITIES DEFINITION OF PERMEABLE PAVING

CONCRETE PAVING OR PAVERS UNDER OVERHANG, NOT COUNTED IN GREEN FACTOR

— GREEN SCREEN METAL LATTICE, SEE GREEN FACTOR EXHIBIT SHEETS FOR WIDTH BY HEIGHT DIMENSIONS

GREEN SCREEN CAN ALSO BE A WOOD FRAME FENCE WITH GALVANIZED OR POWDER COATED METAL MESH SUCH AS WILDHOG AVAILABLE AT DUNN LUMBER OR MESH PANELS FROM ALL CITY FENCE. MESH MUST BE HEAVY DUTY, AND NOT CONCRETE REINFORCING MESH.

ALL PLANTINGS AND LANDSCAPE ELEMENTS REQUIRED AS PART OF THIS BUILDING PERMIT MUST BE MAINTAINED FOR THE LIFE OF THE PROJECT. IF ALTERATIONS OR FAILURES REDUCE LANDSCAPE FEATURES TO A LEVEL BELOW THE MINIMUM REQUIRED PLANTING AREA OR GREEN FACTOR SCORE, NEW FEATURES MUST BE ADDED TO COMPENSATE. THIS REQUIREMENT ALSO APPLIES TO LANDSCAPE IMPROVEMENTS IN THE RIGHT-OF-WAY.

SEE ARCHITECTURAL PLANS FOR AMENITY SPACE CALCULATIONS



DATE: 12-5-2018
SCALE: ON PLAN
DRAWN BY: NB
JOB:
SHEET:

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REVISIONS

/ 1 9-18-2019

This landscape plan is diagrammatic, all dimensions are approximate and must be field verified.

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GHA Landscape Architects

1417 NE 80th St. SEATTLE, WA 98115 TELE 206.522.2334 FAX 206.526.5667

APPROVAL

and

Neil Buchanan

OJECT

L1.0

of 3 SHEETS

REMOVE PINE TREE, SEE NOTES THIS PM LANDSCAPE PLANS 1


1/8" = 1'-0"




Green Factor Worksheet* SEATTLE × green factor													
		Planting Area					Р	ermeable	Paving	G	reen Scree	1	
		101	102	103	104	105		201			301	302	TOTAL
A1	square feet												0
A2	square feet	240	263	171	414								1088
А3	square feet					117							117
В1	square feet	240	263	171	414	117							1205
B2	# of plants	0	29	8	45	13							95
ВЗ	# of trees												0
В4	# of trees												0
B5	# of trees				1								1
В6	# of trees	1											1
В7	# of trees												0
C1	square feet												0
C2	square feet												0
D	square feet										204	168	372
Е	square feet												0
F1	square feet												0
F2	square feet							1252					1252
G	square feet												0
H1	square feet	240	263	171	414								1088
H2	square feet												0
H3	square feet	590	611	267									1468
H4	square feet	550	011	201									0

^{*} See Green Factor score sheet for category definitions

^{**} Enter totals on the Green Factor score sheet

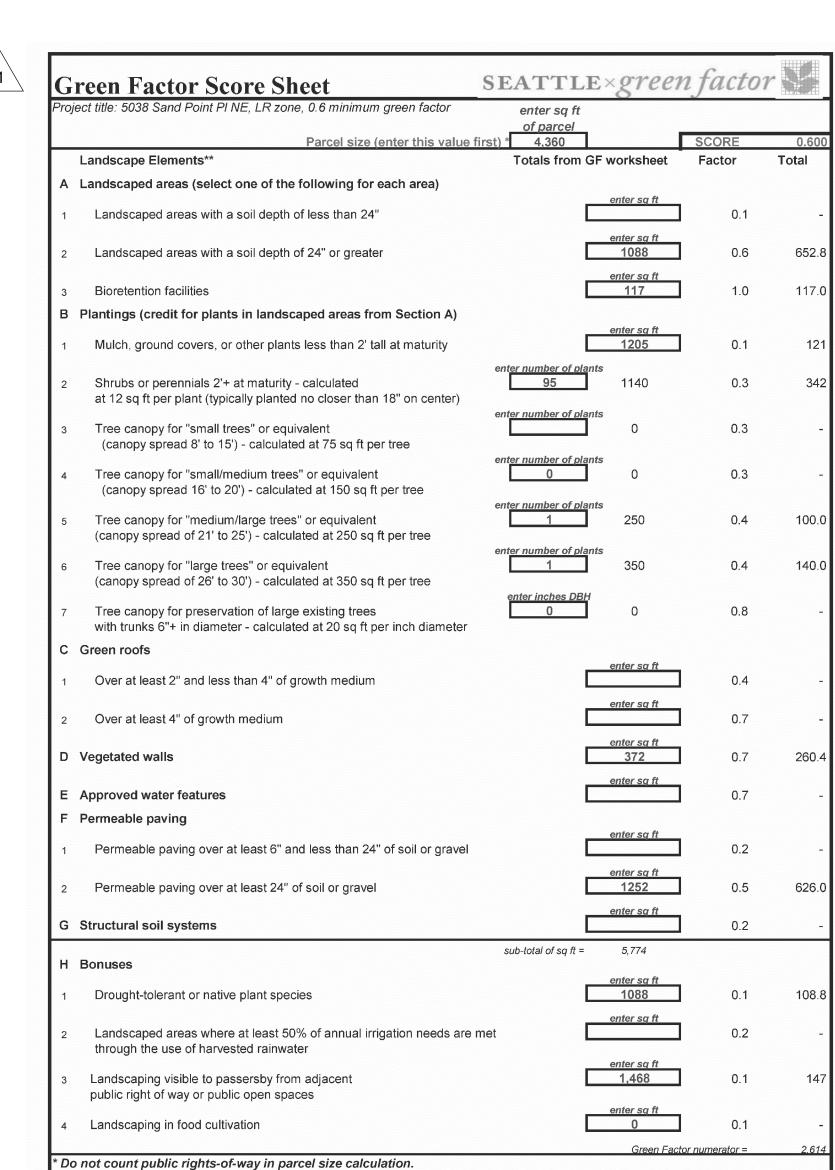

property must comply with the Landscape Standards Director's Rule (DR 6-2009)

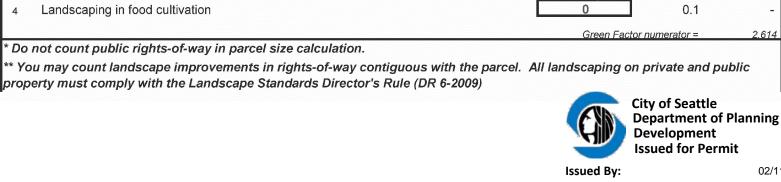

REVISION SUBMIT

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APPROVAL

and

5038

STATE OF WASHINGTON REGISTERED LANDSCAPE ARCHITECT

Neil Buchanan

DATE: 12-5-2018

SCALE: ON PLAN

2 of 3 SHEETS

DRAWN BY: NB

SHEET:

Department of Planning 02/11/2020

GREEN FACTOR EXHIBIT 1/8" = 1'-0"

5.0'

REMOVE PINE

TREE, SEE NOTES THIS



14.5'

(201) ALL PERMEABLE

15.5'


32.0'

32.0'

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29.0'

TREE PLANTING DETAIL

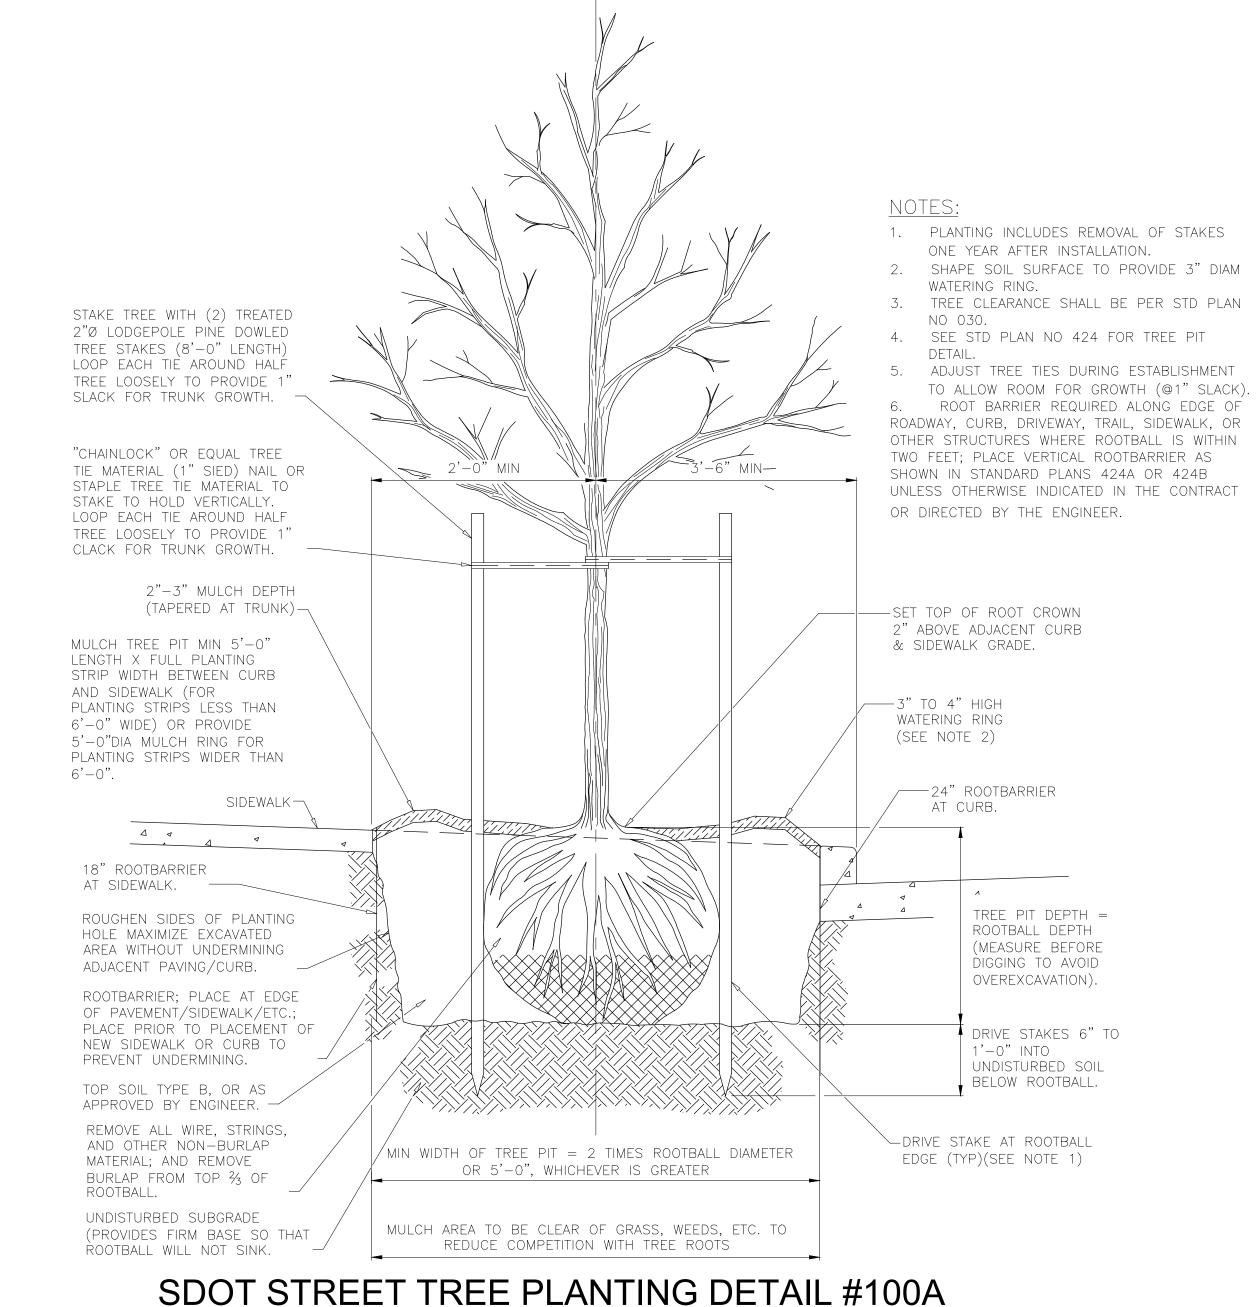

FORM 2" WATER BASIN TOP OF ROOT CROWN BARK MULCH PER SPECIFICATIONS KEEP MULCH 1-2" AWAY FROM STEM OF PLANT EXISTING SOIL, DEEPLY SCARIFY AT SIDES OF PLANT POCKET BACKFILL WITH AMENDED NATIVE SOIL AND FERTILIZER PER SPECIFICATIONS SET AT 1/2" HIGHER THAN GROWN IN NURSERY PLANTING HOLE FIRM BACKFILL IN PLACE AND WATER IN WELL TO BE 12" WIDER THAN ROOTBALL FOR SHRUBS AND 8" WIDER THAN ROOTBALL FOR GROUNDCOVERS DEPTH TO BE SAME AS ROOTBALL OR 12" WHICH EVER IS GREATER

SHRUB PLANTING DETAIL

LANDSCAPE CONSTRUCTION NOTES

Contractor shall familiarize themselves with the project including all underground utilities.

Subgrade for shrub areas to be 8" below finished grade to allow for topsoil and mulch. Subgrade for lawn areas to be 4" below finished grade to allow for topsoil. Beds to be weed and debris free. Till/loosen/excavate existing soil to depth of 10". Add 2.5" of 50/50 Cedar Grove compost/sand mix to shrub areas. Till into 8" of existing soil. Add 3.5" of 50/50 Cedar Grove compost/sand mix to shrub and lawn areas. Till into 8" of soil. Compact soil to 80% to prevent settling. Coordinate soil level in lawn areas with thickness of sod.

Notify owner if existing soil conditions will prove detrimental to plant health, even after soil prep, such as excessive clay soil, hardpan soil, poor drainage, or excessive gravel.

If project includes creating planting areas where pavement or a driveway is located, over excavate so that all underlying gravel base is removed. Add sandy loam soil in 8" lifts and compact to 85% if necessary to build up area to subgrade depth specified above. Then follow soil prep. instructions above.

For bioretention planters, bottom of cell is to be 50"+/-, (see architectura/civil plans) below concrete edge of cell. This is to allow for 18" of clean aggregate, filter fabric, 18" of soil, 2" of mulch, 6" of detention, and 6" of free board. Soil for bioretention cell to be Cedar Grove Bioretention Soil Mix or approved equal. Place in 6" lifts compacted to 80% to prevent settling. See also City of Seattle CAM 536 "Bioretention Planters".

Plant trees and shrubs per details this sheet. Mulch beds at with 2" of medium fine Fir bark.

Mulch is to be free of garbage and weeds and may not contain excessive resin, tannin, or other material detrimental to plant growth.

Gently loosen roots of container stock that is rootbound prior to planting.

Fertilize all plants with best-Paks fertilizer, available at Horizon Inc. 425-828-4554.

One packet per 1 gallon plant, 2 per 2 gallon, 3 per 5 gallon, and 12 per tree. Evenly space packets around rootball, 6-8" from soil surface.

All plants shall conform to America standard for nursery stock, ANLA.

All plants shall be considered very good or better in health and form based on industry standards.

Provide one year warranty for all work starting form date of final acceptance.

Coordinate all work with General Contractor.

Owner is responsible for providing watering through at least the two growing seasons.

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DATE: 12-5-2018 SCALE: ON PLAN DRAWN BY: NB SHEET:

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Neil Buchanan

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GHA Landscape Architects

1417 NE 80th St. SEATTLE, WA 98115 IELE 206.522.2334 FAX 206.526.5667

1 PLANT SCHEDULE



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DATE: 12-5-2018 SCALE: ON PLAN DRAWN BY: NB UBMI. SHEET:

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REVISIONS

1\9-18-2019

This landscape plan is diagrammatic, dimensions are approximate and must be field verified.

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1417 NE 80th St. SEATTLE, WA 98115 TELE 206.522.2334 FAX 206.526.5667

APPROVAL

and

Neil Buchanan

PRO

of 3 SHEETS


LANDSCAPE PLANS 1 1/8" = 1'-0"





CONTACT BEN ROBERTS, SDOT URBAN FORESTRY.

ALL PLANTINGS AND LANDSCAPE ELEMENTS REQUIRED AS PART OF THIS BUILDING PERMIT MUST BE MAINTAINED FOR THE LIFE

SEE ARCHITECTURAL PLANS FOR AMENITY SPACE CALCULATIONS

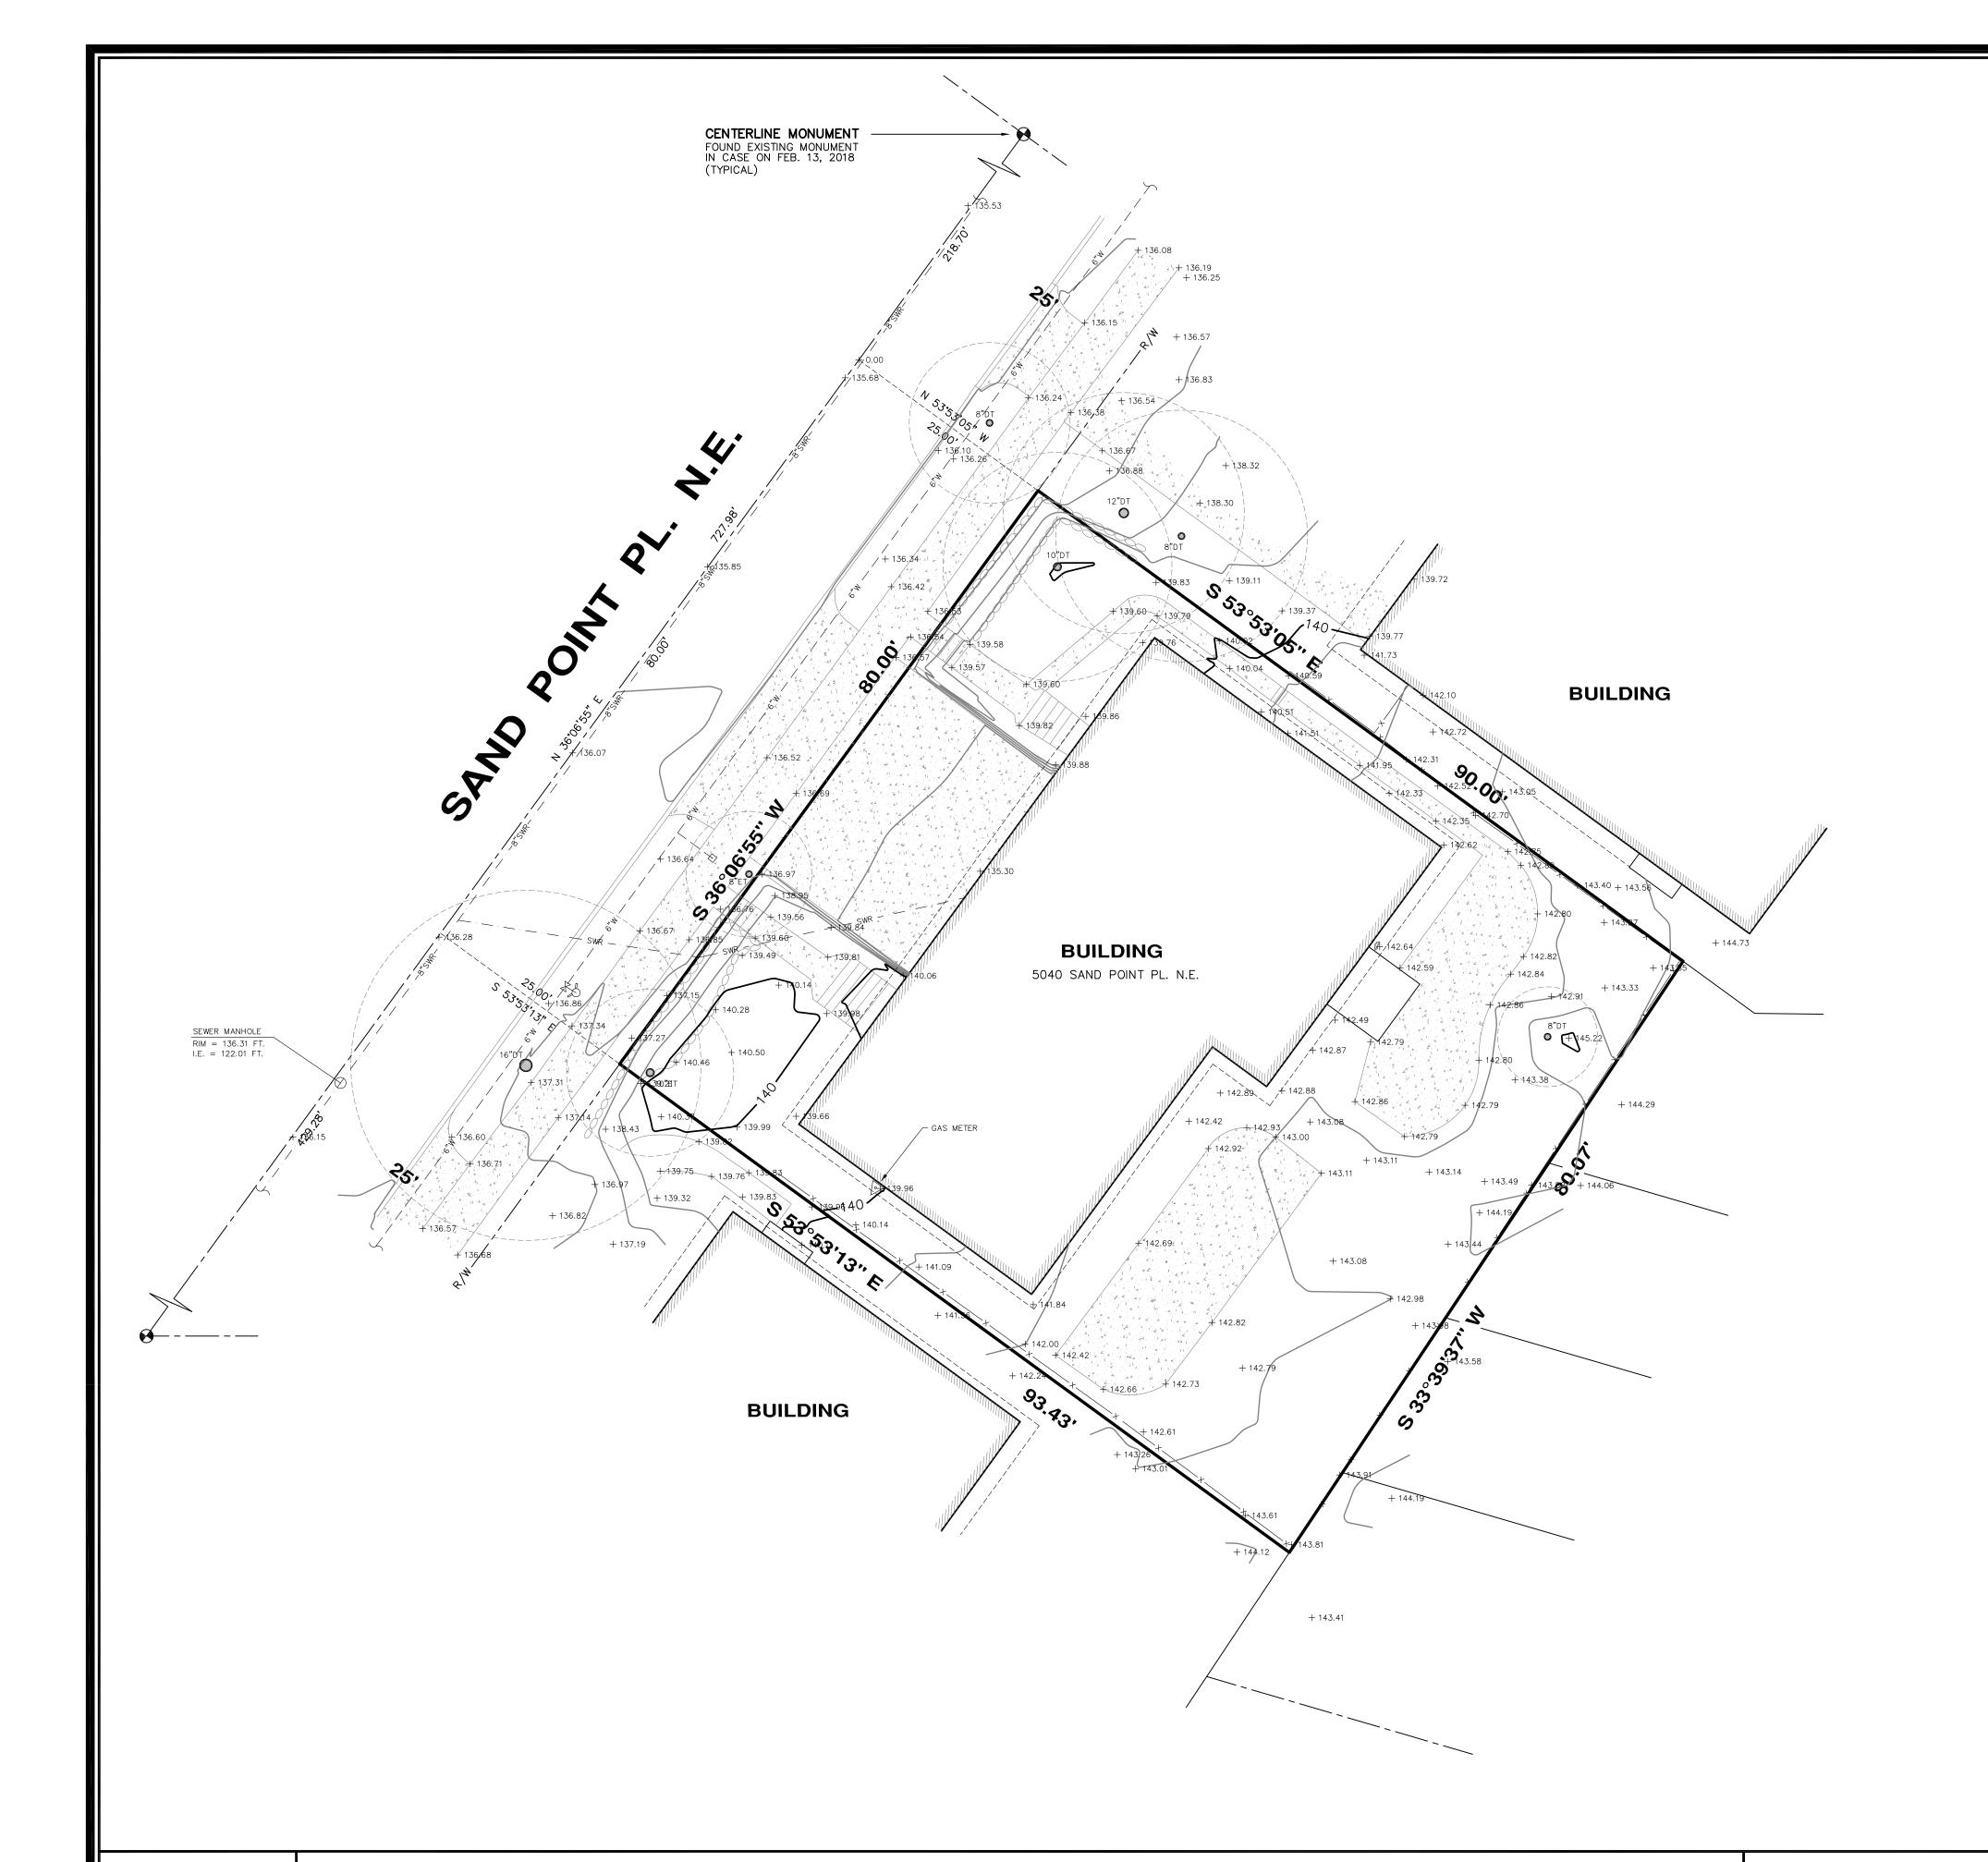

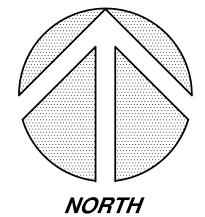

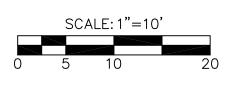


NOTES

- 1. THIS SURVEY WAS PERFORMED BY FIELD TRAVERSE USING A 10 SECOND "TOTAL STATION" THEODOLITE SUPPLEMENTED WITH A 100 FT. STEEL TAPE. THIS SURVEY MEETS OR EXCEEDS THE STANDARDS FOR LAND BOUNDARY SURVEYS AS SET FORTH IN WAC CHAPTER 332-130-090.
- 2. CONTOUR INTERVAL = 1 FT.
- 3. ELEVATION DATUM = NAVD'88 AS PER DIRECT TIES USING GPS EQUIPMENT
- 4. PARCEL AREA = 7,337 SQ. FT.
- 5. THIS SURVEY WAS PREPARED WITHOUT THE BENEFIT OF A CURRENT TITLE REPORT. THEREFORE EASEMENTS THAT AFFECT THIS PROPERTY, IF ANY, ARE NOT SHOWN HEREON.
- 6. UNDERGROUND UTILITY INFORMATION AS SHOWN HEREON IS APPROXIMATE ONLY AND IS BASE UPON CITY OF SEATTLE G.I.S. AND ALSO AS PER TIES TO ABOVE GROUND STRUCTURES.
- 7. TAX PARCEL NO. 0394500065

PROPERTY DESCRIPTION

LOT 3, BLOCK 2, ALBERT BALCHS BALCHWOOD ADDITION TO THE CITY OF SEATTLE ACCORDING TO THE PLAT THEREOF RECORDED IN VOLUME 60 OF PLATS, PAGE 70, RECORDS OF KING COUNTY, WA.

FOR REFERENCE ONLY

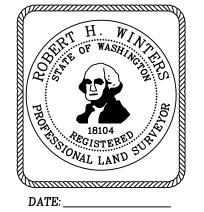

TOPOGRAPHIC SURVEY
5040 SAND POINT PL. N.E.
SEATTLE, WASHINGTON

CHADWICK WINTERS

LAND SURVEYING AND MAPPING

1422 N.W. 85TH ST., SEATTLE, WA 98117

PHONE: 206.297.0996

FAX: 206.297.0997

WEB: WWW.CHADWICKWINTERS.COM

PROJECT #: 18-6048

drawing: 18-6048.DWG BEW

client: MRN HOMES

SHORT SUBDIVISION NO. 3032151-LU

GRANTOR: MRN HOMES, LLC.

SEATTLE, WA 98115

7556 12TH AVE. N.E.

CONTACT PERSON:

IZABELLA PHILLIPS

206.297.0996 IZABELLAP@CHADWICKWINTERS.COM

GRANTEE: CITY OF SEATTLE

KING CO., WA.

ABBREVIATED LEGAL: LOT 3, BLOCK 2, ALBERT BALCHS

BALCHWOOD ADD'N, VOL. 60 OF

PLATS, PAGE 70

PROPERTY ADDRESS:

5040 SAND POINT PL. N.E.

ASSESSOR'S PARCEL #: 0394500065

REFERENCE NO.'S FOR RELATED PROJECTS:

APPROVAL:

CITY OF SEATTLE

SEATTLE DEPARTMENT OF CONSTRUCTION AND INSPECTIONS

NATHAN TORGELSON, DIRECTOR

EXAMINED AND APPROVED THIS 25" DAY OF SEPTEMBER 2019

BY: CONTINUED FOR THE DIRECTOR

APPROVAL OF THIS SHORT SUBDIVISION BY THE DIRECTOR OF THE SEATTLE DEPARTMENT OF CONSTRUCTION AND INSPECTIONS UNDER CHAPTER 23.24 OF THE SEATTLE MUNICIPAL CODE, AS AMENDED, IS NOT TO BE CONSTRUED AS SATISFACTION

OF ANY OTHER APPLICABLE LEGISLATION OR REGULATIONS.

KING COUNTY DEPT. OF ASSESSMENTS

EXAMINED AND APPROVED THIS DAY OF OCTOBER

John Wilson

DEPUTY ASSESSOR:

W.U.C.I.O.A. DECLARATION

THE FOLLOWING STATEMENT IS PROVIDED IF AND TO THE EXTENT THIS UNIT LOT SUBDIVISION IS CONSTRUED AS A COMMON INTEREST COMMUNITY UNDER THE WASHINGTON UNIFORM COMMON INTEREST OWNERSHIP ACT ("WUCIOA"):

THE ONLY PORTIONS OF WUCIOA THAT APPLY TO THIS UNIT LOT SUBDIVISION ARE RCW SECTIONS 64.90.020, 64.90.025, AND 64.90.030 BECAUSE:

- A. THIS UNIT LOT SUBDIVISION CONTAINS NO MORE THAN TWELVE UNIT LOTS:
- B. THIS UNIT LOT SUBDIVISION IS NOT SUBJECT TO ANY DEVELOPMENT RIGHTS AS THAT TERM IS DEFINED IN WUCIOA;
- C. THE DECLARANT FOR THIS UNIT LOT SUBDIVISION (THE "DECLARANT") HAS NOT ESTABLISHED OR STATED ANY ASSESSMENTS FOR THE UNIT LOTS. HOWEVER, THIS UNIT LOT SUBDIVISION MAY CONTAIN OBLIGATIONS ON THE OWNERS OF THE UNIT LOTS FOR CERTAIN MAINTENANCE AND OTHER OBLIGATIONS OUTSIDE THE OWNER'S UNIT LOT. THE DECLARANT BELIEVES IN GOOD FAITH THAT THE COST OF THESE MAINTENANCE AND OTHER OBLIGATIONS WILL NOT EXCEED THE AMOUNT SPECIFIED IN RCW 64.90.075; AND
- D. THE LIMITATIONS STATED IN PARAGRAPH C ABOVE WILL NOT BE EXCEEDED PRIOR TO NINETY (90) DAYS AFTER THE DATE THE DECLARANT HAS CONVEYED SEVENTY-FIVE PERCENT (75%) OF THE UNIT LOTS UNLESS APPROVED BY 90% OF THE OWNERS OF THE UNIT LOTS OTHER THAN THE DECLARANT.
- E. THIS UNIT LOT SUBDIVISION IS A DECLARATION UNDER WUCIOA.

DECLARATION:

WE THE UNDERSIGNED, OWNER(S) IN FEE SIMPLE [AND CONTRACT PURCHASER(S)] OF THE LAND HEREIN DESCRIBED DO HEREBY MAKE A SHORT SUBDIVISION THÈREOF PURSUANT TO RCW 58.17.060 AND DECLARE THIS SHORT PLAT TO BE THE GRAPHIC REPRESENTATION OF SAME, AND THAT SAID SHORT SUBDIVISION IS MADE WITH THE FREE CONSENT AND IN ACCORDANCE WITH THE DESIRE OF THE OWNER(S). IN WITNESS WHEREOF WE HAVE SET OUR HANDS AND SEALS.

NAME: MRN Homes LLC

____ ITS Managing Member

STATE OF WASHINGTON)

COUNTY OF KING

ON THIS 2111 DAY OF AUGUST 2019 BEFORE ME, THE UNDERSIGNED, A NOTARY PUBLIC IN AND FOR THE STATE OF WASHINGTON, DULY COMMISSIONED AND SWORN, PERSONALLY APPEARED MICHELLA MEMBER MRN Hemes IIC , TO ME KNOWN TO BE THE INDIVIDUAL DESCRIBED IN AND WHO EXECUTED THE FOREGOING INSTRUMENT FOR THEMSELVES, AND ACKNOWLEDGED TO ME THAT THEY SIGNED AND SEALED THE SAME AS THEIR VOLUNTARY ACT FOR THE USES AND PURPOSES THEREIN MENTIONED.

WITNESS MY HAND AND OFFICIAL SEAL HERETO AFFIXED THE DAY AND YEAR IN THIS CERTIFICATED WRITTEN

NOTARY PUBLIC IN AND FOR THE STATE OF WASHINGTON RESIDING AT Seattle WA

FOR REFERENCE ONLY

FILED FOR RECORD THIS 2 DAY OF 2019
AT 10:59 A.M. IN VOLUME 412 OF SURVEYS,
PAGE 089 AT THE REQUEST OF CHADWICK & WINTERS.

DEPARTMENT OF RECORDS & ELECTIONS

MANAGER

SURVEYOR'S CERTIFICATE

THIS MAP CORRECTLY REPRESENTS A SURVEY MADE BY ME OR UNDER MY DIRECTION IN CONFORMANCE WITH THE REQUIREMENTS OF THE SURVEY RECORDING

CHADWICK? WINTERS 1

LAND SURVEYING AND MAPPING 1422 N.W. 85TH ST., SEATTLE, WA 98117


PHONE: **206.297.0996** FAX: **206.297.0997** WEB: WWW.CHADWICKWINTERS.COM


SURVEY IN: NE 1/4, SW 1/4, SEC. 10, T. 25 N., R. 4 E., W.M. KING COUNTY, WASHINGTON

REVISED: 10/11/18 18-6048X.DWG

DRAWN BY: SAL PROJECT #: 18-6048 DATE: 05-21-18 CHK. BY: RHW SCALE: N/A SHEET: 1 OF 7

SHORT SUBDIVISION NO. 3032151-LU CENTERLINE MONUMENT FOUND EXISTING MONUMENT IN CASE ON FEB. 13, 2018 (TYPICAL) TAX NO. 0394500065 रेंड,

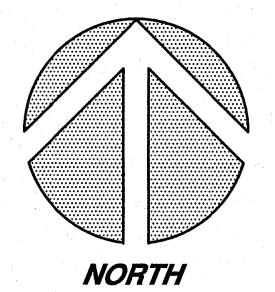

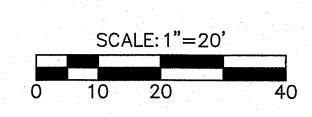

SURVEY NOTES:

- 1. THIS SURVEY WAS PERFORMED BY FIELD TRAVERSE USING A 10 SECOND "TOTAL STATION" THEODOLITE SUPPLEMENTED WITH A 100 FT. STEEL TAPE. THIS SURVEY MEETS OR EXCEEDS THE STANDARDS FOR LAND BOUNDARY SURVEYS AS SET FORTH IN WAC CHAPTER 332-130-090.
- 2. BASIS OF BEARINGS = N 36°06'55" E BETWEEN THE TWO FOUND MONUMENTS IN THE CENTERLINE OF SAND POINT PL. N.E. AS SHOWN HEREON.
- 3. ALL EXISTING STRUCTURES AS SHOWN ON SHEET 3 ARE TO BE LEGALLY REMOVED UNDER SEPARATE PERMIT.
- 4. PARCEL AREA = 7,337 SQ. FT.
- 5. THE SUBDIVISION OF THE PROPERTY WILL NOT REDUCE THE REQUIREMENTS OF THE CITY OF SEATTLE STORMWATER CODE AND THE CITY OF SEATTLE SIDE SEWER CODE. FOR THE PURPOSES OF ENSURING COMPLIANCE WITH THE INTENT OF THE CITY OF SEATTLE STORMWATER CODE AND THE CITY OF SEATTLE SIDE SEWER CODE, THE PROPOSED PARCELS WITHIN THIS SUBDIVISION WILL MEET THE STANDARDS REQUIRED BY THE HIGHER AREA THRESHOLD OF THE ENTIRE PROPERTY BEING SUBDIVIDED OR THE ENTIRE DEVELOPMENT, WHICHEVER IS LARGER, RATHER THAN THE STANDARDS REQUIRED FOR EACH OF THE PROPOSED PARCELS INDIVIDUALLY.
- 6. DRAINAGE REVIEW CONDITION: FLOW CONTROL TO MEET THE PRE-DEVELOPED PASTURE STANDARD AND PEAK FLOW CONTROL STANDARD SHALL BE PROVIDED WITH THE BUILDING CONSTRUCTION PERMIT ASSOCIATED WITH THE PROPOSED DEVELOPMENT PLAN OF PARCELS.


PROPERTY DESCRIPTION

LOT 3, BLOCK 2, ALBERT BALCHS BALCHWOOD ADDITION TO THE CITY OF SEATTLE ACCORDING TO THE PLAT THEREOF RECORDED IN VOLUME 60 OF PLATS, PAGE 70, RECORDS OF KING COUNTY, WA.

FOR REFERENCE ONLY

BLOCK & BOUNDARY DETAIL

N.E. 50TH ST.

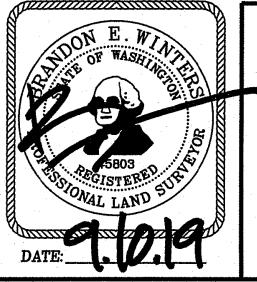

CHADWICK WINTERS


LAND SURVEYING AND MAPPING
1422 N.W. 85TH ST., SEATTLE, WA 98117

PHONE: **206.297.0996**FAX: **206.297.0997**WEB: **WWW.CHADWICKWINTERS.COM**

SURVEY IN:
NE 1/4, SW 1/4, SEC. 10, T. 25 N., R. 4 E., W.M.
KING COUNTY, WASHINGTON

18-6048X.DW

DRAWN BY: SAL	DATE:	05-21-18	PROJECT #: 18-6048
CHK. BY: RHW	SCALE:	1" = 20'	SHEET: 2 OF 7

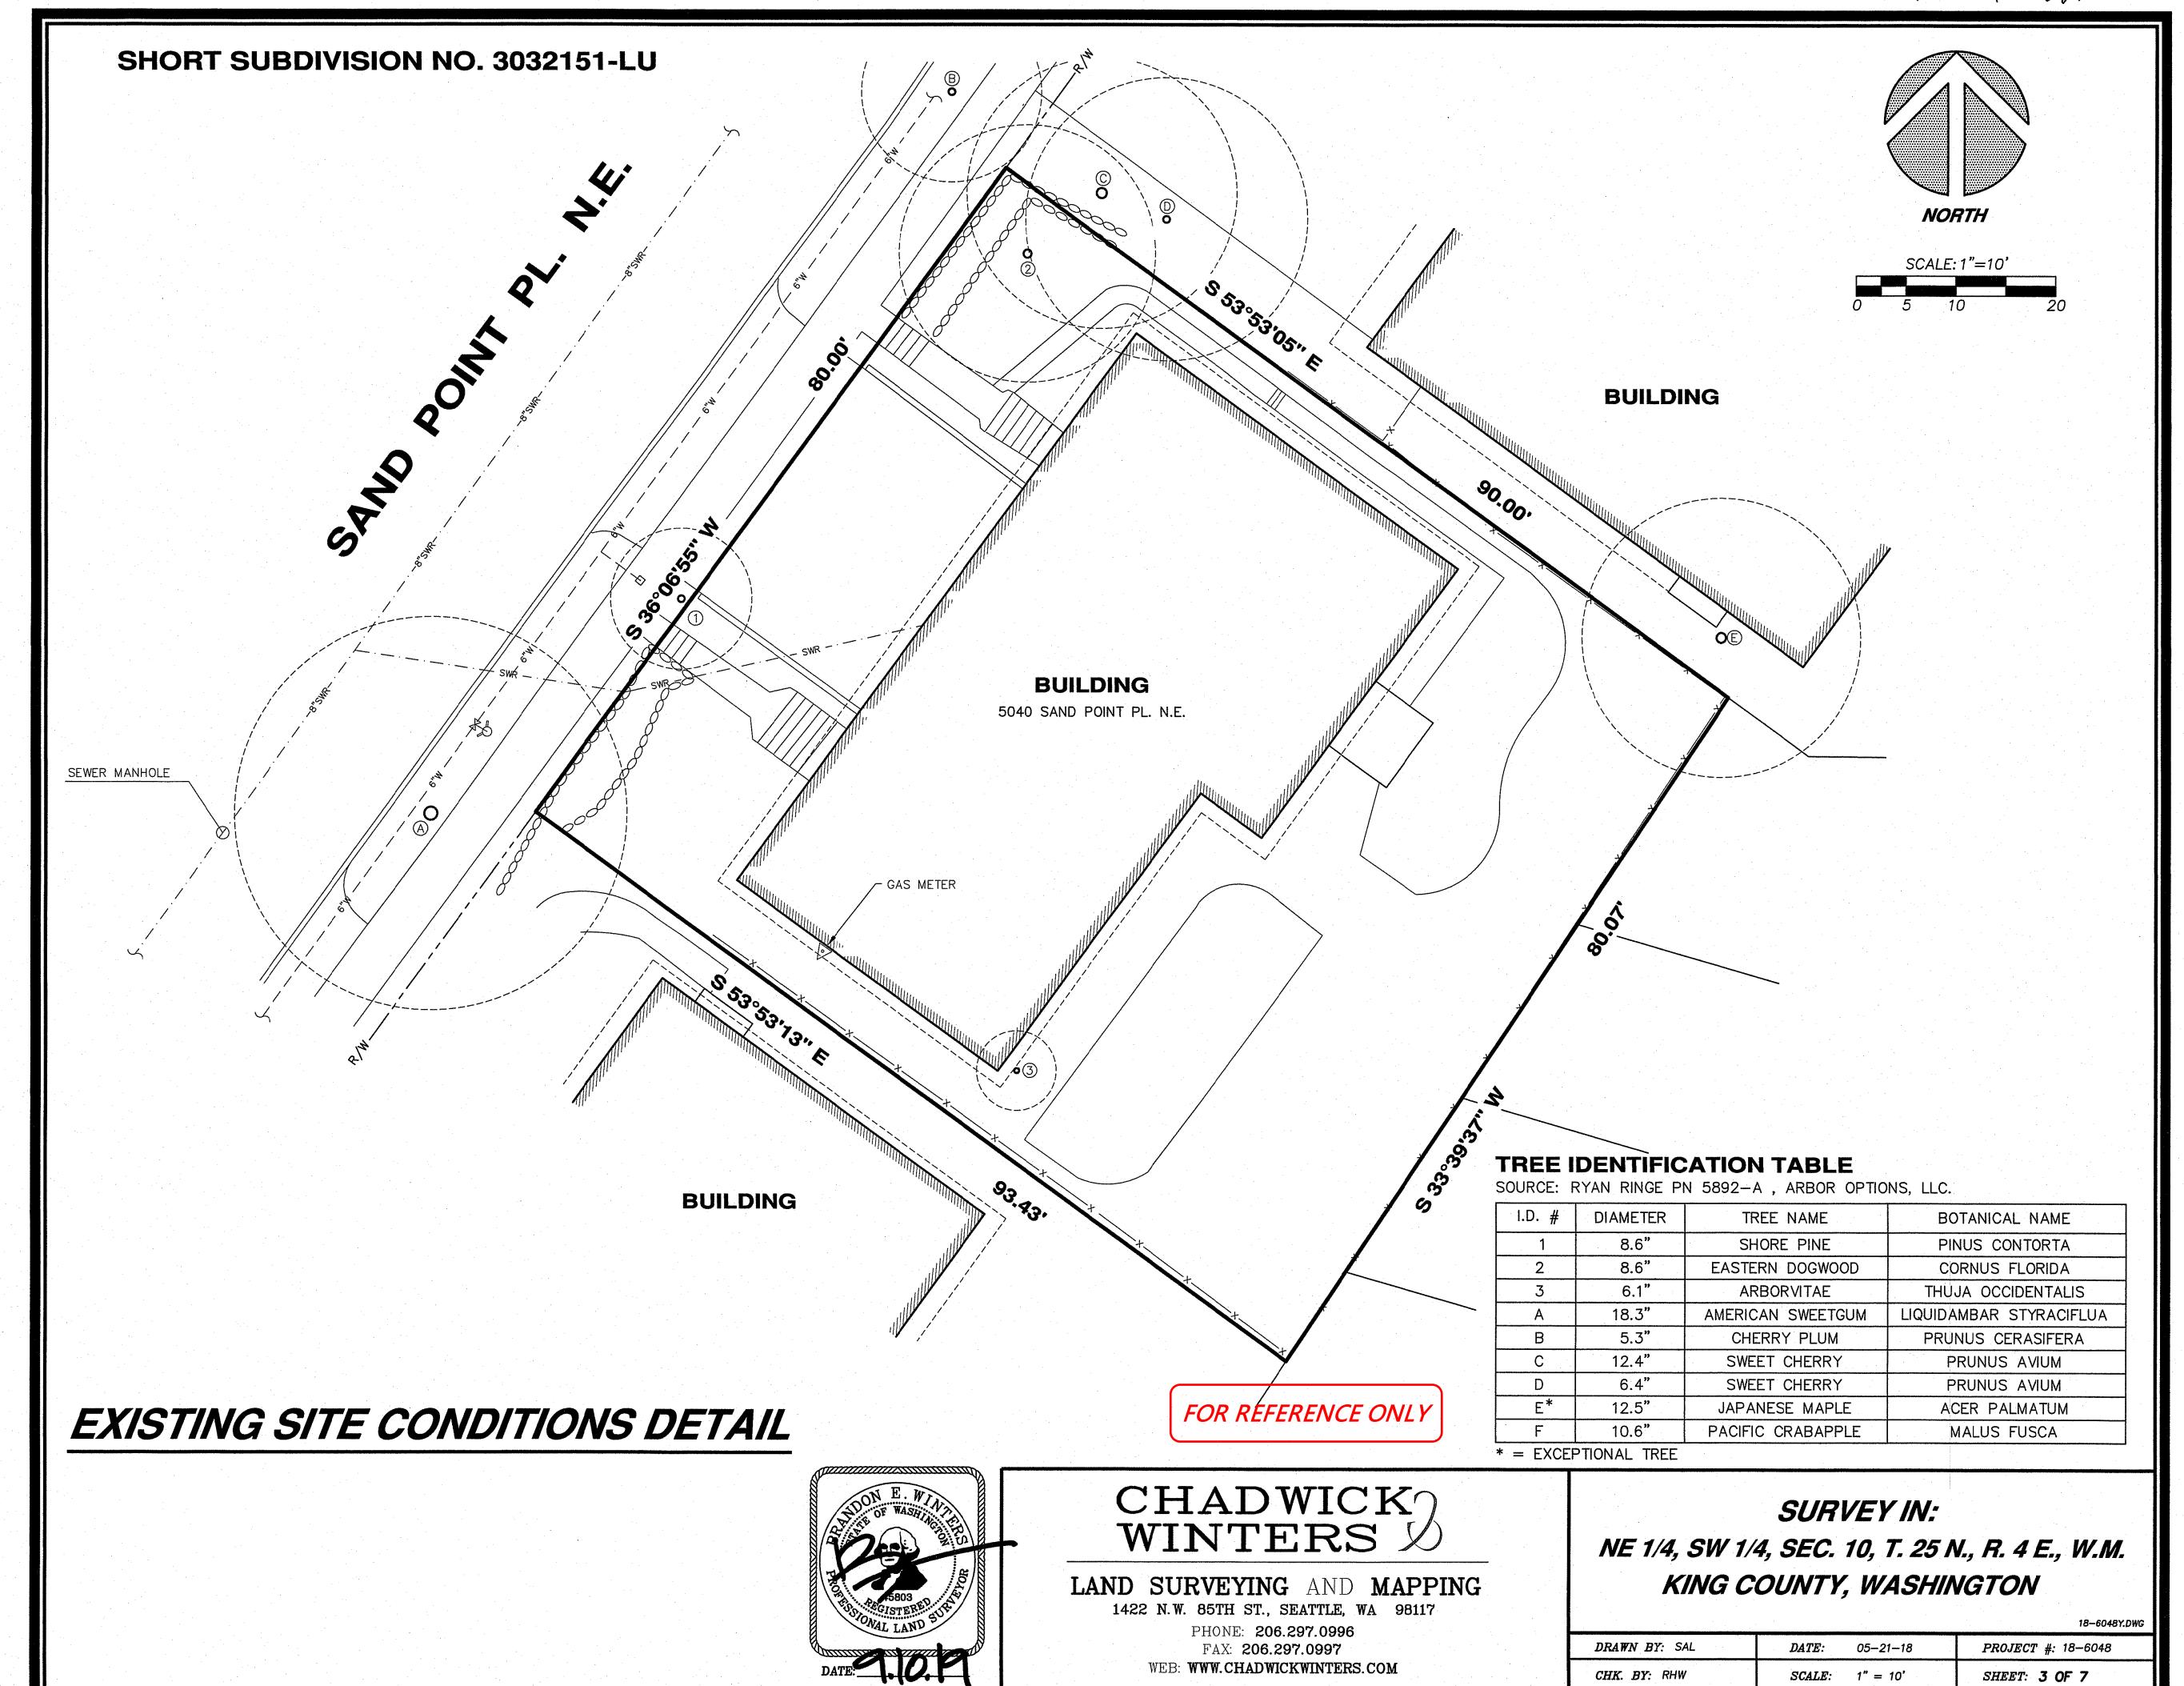

SHORT SUBDIVISION NO. 3032151-LU **NORTH** SCALE: 1"=10' PARCEL A (4,360 SQ. FT.) 5038 SAND POINT PL. N.E. PARCEL B (2,977 SQ. FT.) 5042 SAND POINT PL. N.E. S 53°53'13" E FOR REFERENCE ONLY CHADWICK WINTERS SURVEY IN: NE 1/4, SW 1/4, SEC. 10, T. 25 N., R. 4 E., W.M. SHORT SUBDIVISION DETAIL LAND SURVEYING AND MAPPING KING COUNTY, WASHINGTON

1422 N.W. 85TH ST., SEATTLE, WA 98117

PHONE: **206.297.0996**FAX: **206.297.0997**

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DRAWN BY: SAL

CHK. BY: RHW

DATE: 05-21-18


SCALE: 1" = 10'

PROJECT #: 18-6048

SHEET: 4 OF 7

SHORT SUBDIVISION NO. 3032151-LU **NORTH** SCALE: 1"=10' - ACCESS EASEMENT
LOCATION OF INGRESS, EGRESS,
ADDRESS SIGN AND PEDESTRIAN
ACCESS EASEMENT BENEFICIAL TO
PARCELS A AND B WITHIN THIS
SHORT SUBDIVISION AN ADDRESS SIGN FOR PARCEL B-IS TO BE POSTED AT A LOCATION VISIBLE FROM SAND POINT PL. N.E. AND IS TO BE MAINTAINED BY SAID PARCEL PARCEL A PARCEL B LINE TABLE LINE BEARING LENGTH FOR REFERENCE ONLY S 53°53'05" E S 36°06'55" W

ACCESS EASEMENT DETAIL

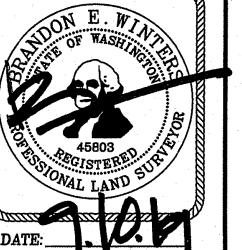

CHADWICK WINTERS

LAND SURVEYING AND MAPPING 1422 N.W. 85TH ST., SEATTLE, WA 98117

PHONE: **206.297.0996**FAX: **206.297.0997** WEB: WWW.CHADWICKWINTERS.COM

SURVEY IN:

NE 1/4, SW 1/4, SEC. 10, T. 25 N., R. 4 E., W.M. KING COUNTY, WASHINGTON

18-6048Y.DWG	ı
	-

DRAWN BY: SAL	DATE: 05-21-18	PROJECT #: 18-6048
CHK. BY: RHW	SCALE: 1" = 10'	SHEET: 5 OF 7

SHORT SUBDIVISION NO. 3032151-LU **NORTH** SCALE: 1"=10' - SEATTLE CITY LIGHT EASEMENT
LOCATION OF EXCLUSIVE EASEMENT FOR
SEATTLE CITY LIGHT UNDERGROUND
UTILITIES BENEFICIAL TO PARCEL B
WITHIN THIS SHORT SUBDIVISION PARCEL A UTILITY EASEMENT —
LOCATION OF UNDERGROUND
UTILITY EASEMENT BENEFICIAL
TO PARCEL B WITHIN THIS
SHORT SUBDIVISION PARCEL B S 53°53'73", E FOR REFERENCE ONLY CHADWICK SURVEY IN: WINTERS 1 NE 1/4, SW 1/4, SEC. 10, T. 25 N., R. 4 E., W.M. EASEMENT DETAIL KING COUNTY, WASHINGTON LAND SURVEYING AND MAPPING 1422 N.W. 85TH ST., SEATTLE, WA 98117 PHONE: 206.297.0996 DRAWN BY: SAL PROJECT #: 18-6048 FAX: **206.297.0997** DATE: 05-21-18

WEB: WWW.CHADWICKWINTERS.COM

CHK. BY: RHW

SCALE: 1" = 10'

SHEET: 6 OF 7

SHORT SUBDIVISION NO. 3032151-LU

PROPOSED PARCEL DESCRIPTIONS:

PARCEL A (4,360 SQ. FT.)

THAT PORTION OF LOT 3, BLOCK 2, ALBERT BALCHS BALCHWOOD ADDITION TO THE CITY OF SEATTLE ACCORDING TO THE PLAT THEREOF RECORDED IN VOLUME 60 OF PLATS, PAGE 70, RECORDS OF KING COUNTY, WA. BEING MORE PARTICULARLY DESCRIBED AS FOLLOWS:

BEGINNING AT THE NORTHERLY MOST CORNER OF SAID LOT 3; THENCE S 53°53'05" E, ALONG THE NORTHEASTERLY LINE OF SAID LOT FOR A DISTANCE OF 54.50 FT.; THENCE S 36°06'55" W, 80.00 FT.; THENCE N 53°53'13" W. 54.50 FT.; THENCE N 36°06'55" E, 80.00 FT. TO THE POINT OF BEGINNING.

SUBJECT TO AND TOGETHER WITH AN EASEMENT FOR INGRESS, EGRESS, ADDRESS SIGN AND PEDESTRIAN ACCESS AS SHOWN AND DESCRIBED AS "ACCESS EASEMENT" ON THIS CITY OF SEATTLE SHORT SUBDIVISION.

SUBJECT TO AN EASEMENT FOR UNDERGROUND UTILITIES AS SHOWN AND DESCRIBED AS "UTILITY EASEMENT" ON THIS CITY OF SEATTLE SHORT SUBDIVISION.

SUBJECT TO AN EXCLUSIVE EASEMENT FOR SEATTLE CITY LIGHT UNDERGROUND UTILITIES AS SHOWN AND DESCRIBED AS "SEATTLE CITY LIGHT EASEMENT" ON THIS CITY OF SEATTLE SHORT SUBDIVISION.

AND SUBJECT TO AND TOGETHER WITH ALL AGREEMENTS AS SHOWN AND DESCRIBED UPON THIS CITY OF SEATTLE UNIT LOT SUBDIVISION.

PARCEL B (2,997 SQ. FT.)

THAT PORTION OF LOT 3, BLOCK 2, ALBERT BALCHS BALCHWOOD ADDITION TO THE CITY OF SEATTLE ACCORDING TO THE PLAT THEREOF RECORDED IN VOLUME 60 OF PLATS, PAGE 70, RECORDS OF KING COUNTY, WA. BEING MORE PARTICULARLY DESCRIBED AS FOLLOWS:

BEGINNING AT THE SOUTHERLY MOST CORNER OF SAID LOT 3; THENCE N 53°53'13" W, ALONG THE SOUTHWESTERLY LINE OF SAID LOT FOR A DISTANCE OF 38.93 FT.; THENCE N 36°06'55" E, 80.00 FT.; THENCE S 53°53'05" E, 35.50 FT.; THENCE S 33°39'37" W, 80.07 FT. TO THE POINT OF BEGINNING.

SUBJECT TO AND TOGETHER WITH AN EASEMENT FOR INGRESS, EGRESS, ADDRESS SIGN AND PEDESTRIAN ACCESS AS SHOWN AND DESCRIBED AS "ACCESS EASEMENT" ON THIS CITY OF SEATTLE SHORT SUBDIVISION.

TOGETHER WITH AN EASEMENT FOR UNDERGROUND UTILITIES AS SHOWN AND DESCRIBED AS "UTILITY EASEMENT" ON THIS CITY OF SEATTLE SHORT SUBDIVISION.

TOGETHER WITH AN EXCLUSIVE EASEMENT FOR SEATTLE CITY LIGHT UNDERGROUND UTILITIES AS SHOWN AND DESCRIBED AS "SEATTLE CITY LIGHT EASEMENT" ON THIS CITY OF SEATTLE SHORT SUBDIVISION.

AND SUBJECT TO AND TOGETHER WITH ALL AGREEMENTS AS SHOWN AND DESCRIBED UPON THIS CITY OF SEATTLE UNIT LOT SUBDIVISION.

ACCESS EASEMENT

AN EASEMENT FOR INGRESS, EGRESS, ADDRESS SIGN AND PEDESTRIAN ACCESS BENEFICIAL TO PARCELS A AND B OF THIS SHORT SUBDIVISION

THAT PORTION OF LOT 3, BLOCK 2, ALBERT BALCHS BALCHWOOD ADDITION TO THE CITY OF SEATTLE ACCORDING TO THE PLAT THEREOF RECORDED IN VOLUME 60 OF PLATS, PAGE 70, RECORDS OF KING COUNTY. WA. BEING MORE PARTICULARLY DESCRIBED AS FOLLOWS:

COMMENCING AT THE NORTHERLY MOST CORNER OF SAID LOT 3; THENCE S 36°06'55" W, ALONG THE NORTHWESTERLY LINE OF SAID LOT FOR A DISTANCE OF 40.00 FT. TO THE **POINT OF BEGINNING**; THENCE S 53°53'05" E, 2.00 FT.; THENCE S 36°06'55" W, 2.00 FT.; THENCE S 53°53'05" E, 32.00 FT.; THENCE N 36°06'55" E, 25.00 FT.; THENCE S 53°53'05" E, 26.50 FT.; THENCE S 36°06'55" W, 53.00 FT.; THENCE N 53°53'13" W, 26.50 FT.; THENCE N 36°06'55" E, 18.00 FT.; THENCE N 53°53'05" W, 34.00 FT.; THENCE N 36°06'55" E, 12.00 FT. TO THE **POINT OF BEGINNING**.

UTILITY EASEMENT

AN EASEMENT FOR UNDERGROUND UTILITIES, INCLUDING BUT NOT LIMITED TO UNDERGROUND WATERLINE, POWER, GAS, TELEPHONE, TELECABLE, SANITARY SEWER AND STORM SEWER BENEFICIAL TO PARCEL B WITHIN THIS SHORT SUBDIVISION

THAT PORTION OF LOT 3, BLOCK 2, ALBERT BALCHS BALCHWOOD ADDITION TO THE CITY OF SEATTLE ACCORDING TO THE PLAT THEREOF RECORDED IN VOLUME 60 OF PLATS, PAGE 70, RECORDS OF KING COUNTY, WA. BEING MORE PARTICULARLY DESCRIBED AS FOLLOWS:

COMMENCING AT THE NORTHERLY MOST CORNER OF SAID LOT 3; THENCE S 36°06'55" W, ALONG THE NORTHWESTERLY LINE OF SAID LOT FOR A DISTANCE OF 47.00 FT. TO THE **POINT OF BEGINNING**; THENCE S 53°53'05" E, 54.50 FT.; THENCE S 36°06'55" W, 5.00 FT.; THENCE N 36°06'55" E, 5.00 FT. TO THE **POINT OF BEGINNING**.

FOR REFERENCE ONLY

ADDRESS SIGN MAINTENANCE AGREEMENT

ANY PARCEL BENEFITING FROM THE POSTING OF THE ADDRESS SIGN AS SHOWN HEREON IS RESPONSIBLE FOR THE MAINTENANCE, SHARING EQUALLY IN THE COST OF REPAIR AND OR MAINTENANCE TO SAID ADDRESS SIGN.

EASEMENT MAINTENANCE AGREEMENT

SAID EASEMENTS OF THIS SHORT PLAT TO BE EQUALLY MAINTAINED, REPAIRED, AND/OR REBUILT BY THE OWNERS OF THE PARCELS HAVING LEGAL ACCESS AND UTILITY SERVICE THEREFROM AND THEIR HEIRS, ASSIGNS AND SUCCESSORS.

INDIVIDUAL UTILITY SERVICE LINES, INCLUDING STORM AND SANITARY SIDE SEWER LINES, ARE THE SOLE RESPONSIBILITY OF THE OWNERS OF THE UNIT OR PARCEL THE INDIVIDUAL SERVICE LINE SERVES. UTILITY SERVICE LINES WHICH SERVICE MORE THAN ONE UNIT OR PARCEL SHALL BE EQUALLY MAINTAINED, REPAIRED, AND/OR REBUILT BY THE OWNERS OF THE UNITS OR PARCELS SERVICED.

THIS MAINTENANCE AGREEMENT COVERS NORMAL USAGE, WEAR AND TEAR, AND LIFE EXPECTANCY OF MATERIALS. ANY DAMAGE INCURRED BY AN INDIVIDUAL OWNER SHALL BE REPAIRED AND/OR RESTORED TO PRE DAMAGED CONDITION WITHIN 30 DAYS. THE OWNER WHICH INCURRED THE DAMAGE SHALL BE SOLELY RESPONSIBLE FOR THE COST OF REPAIR OR REPLACEMENT OF THE MATERIALS. IN NO EVENT SHALL ACCESS OR UTILITY SERVICE BE DENIED OTHER PROPERTY OWNERS OF SAID EASEMENTS FOR MORE THAN 24 HOURS

SEATTLE CITY LIGHT EASEMENT

CITY OF SEATTLE LAND USE ACTION NO. 3032151-LU EXCLUSIVE EASEMENT (UNDERGROUND)
KING COUNTY ASSESSOR'S TAX PARCEL NO. 0394500065

THE OWNER OF THE REAL PROPERTY THAT IS THE SUBJECT OF THIS LAND USE ACTION ("GRANTOR") HEREBY GRANTS TO THE CITY OF SEATTLE ("GRANTEE") AND THE RIGHT, PRIVILEGE AND AUTHORITY (AN "EASEMENT") TO INSTALL, CONSTRUCT, ERECT, RECONSTRUCT, ALTER, IMPROVE, REMOVE, REPAIR, REPLACE, ENERGIZE, OPERATE, AND MAINTAIN UNDERGROUND ELECTRIC DISTRIBUTION FACILITIES, WHICH MAY CONSIST OF, BUT ARE NOT LIMITED TO: TRANSFORMERS, DUCTS, VAULTS, MANHOLES, SWITCHES, CABINETS, CONTAINERS, CONDUITS, WIRES AND OTHER CONVENIENT APPURTENANCES NECESSARY TO MAKE SAID UNDERGROUND DISTRIBUTION FACILITIES AN INTEGRATED ELECTRIC SYSTEM ("ELECTRIC SYSTEM"). ALL SUCH ELECTRIC SYSTEM SHALL BE LOCATED ACROSS, OVER, UPON AND UNDER THE REAL PROPERTY DESCRIBED WITHIN THIS LAND USE ACTION ("PROPERTY") SITUATED IN THE COUNTY OF KING, STATE OF WASHINGTON, AND MORE PARTICULARLY DESCRIBED AS FOLLOWS:

THAT PORTION OF LOT 3, BLOCK 2, ALBERT BALCHS BALCHWOOD ADDITION TO THE CITY OF SEATTLE ACCORDING TO THE PLAT THEREOF RECORDED IN VOLUME 60 OF PLATS, PAGE 70, RECORDS OF KING COUNTY. WA. BEING MORE PARTICULARLY DESCRIBED AS FOLLOWS:

COMMENCING AT THE NORTHERLY MOST CORNER OF SAID LOT 3; THENCE S 36°06'55" W, ALONG THE NORTHWESTERLY LINE OF SAID LOT FOR A DISTANCE OF 42.00 FT. TO THE POINT OF BEGINNING; THENCE S 53°53'05" E, 54.50 FT.; THENCE S 36°06'55" W, 5.00 FT.; THENCE N 53°53'05" W, 54.50 FT.; THENCE N 36°06'55" E, 5.00 FT. TO THE POINT OF BEGINNING.

(ALSO BEING KNOWN AS THE SEATTLE CITY LIGHT EASEMENT LYING WITHIN PARCEL A OF THIS CITY OF SEATTLE SHORT SUBDIVISION WHICH SHALL BE OCCUPIED AND CONTROLLED EXCLUSIVELY BY SEATTLE CITY LIGHT, A DEPARTMENT OF THE CITY OF SEATTLE.)


TOGETHER WITH GRANTEE'S AND ITS ASSIGNS' UNRESTRICTED RIGHT OF ACCESS TO AND FROM THE PROPERTY FOR THE PURPOSES OF EXERCISING ITS RIGHTS GRANTED HEREIN.

TOGETHER WITH GRANTEE'S AND ITS ASSIGNS' RIGHT TO CUT AND TRIM BRUSH, TREES OR OTHER PLANTS STANDING OR GROWING UPON THE PROPERTY WHICH, IN THE OPINION OF THE GRANTEE, INTERFERE WITH THE MAINTENANCE OR OPERATION OF, OR CONSTITUTE A MENACE OR DANGER TO, THE ELECTRIC SYSTEM.

GRANTOR, ITS SUCCESSORS AND ASSIGNS, COVENANTS AND AGREES THAT NO STRUCTURE OR FIRE HAZARDS WILL BE BUILT OR PERMITTED WITHIN THE EASEMENT AREA(S) DESCRIBED ABOVE; THAT NO DIGGING WILL BE DONE OR PERMITTED WITHIN THE PROPERTY WHICH WILL IN ANY MANNER DISTURB GRANTEE'S ELECTRIC SYSTEM OR ITS SOLIDITY OR UNEARTH ANY PORTION THEREOF; AND THAT NO BLASTING OR DISCHARGE OF ANY EXPLOSIVES WILL BE PERMITTED WITHIN FIFTY (50) FEET OF THE ELECTRIC SYSTEM.

THE CITY OF SEATTLE SHALL BE RESPONSIBLE, AS PROVIDED BY LAW, FOR ANY DAMAGE TO THE GRANTOR THROUGH ITS NEGLIGENCE IN THE CONSTRUCTION, MAINTENANCE AND OPERATION OF THE ELECTRIC SYSTEM.

THE RIGHTS, TITLE, PRIVILEGES AND AUTHORITY HEREBY GRANTED SHALL CONTINUE AND BE IN FORCE UNTIL THE GRANTEE PERMANENTLY REMOVES ITS ELECTRIC SYSTEM FROM THE PROPERTY OR PERMANENTLY ABANDONS THE ELECTRIC SYSTEM, AT WHICH TIME ALL SUCH RIGHTS, TITLE, PRIVILEGES AND AUTHORITY HEREBY GRANTED SHALL TERMINATE.

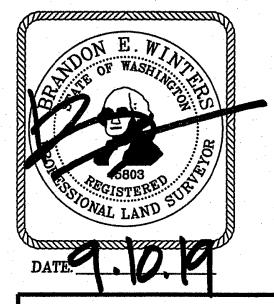

CHADWICK WINTERS

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SURVEY IN: NE 1/4, SW 1/4, SEC. 10, T. 25 N., R. 4 E., W.M. KING COUNTY, WASHINGTON

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DRAWN BY: SAL	DATE: 0	05–21–18	PROJECT #: 18-6048
CHK. BY: RHW	SCALE: 1	" = 20'	SHEET: 7 OF 7